

# THE DEPARTMENT OF FINANCE TEMPORARY TRANSITION AREA 2314 KRONPRINDSENS GADE KRONPRINDSENS QUARTER ST. THOMAS, U.S. VIRGIN ISLANDS

MAP OF ISLAND

		<u>VIATIONS</u>	
Acoustic	ACST or ACOUST	On center	
Above finished floor	AFF	Opening	(
Aluminum	AL or ALUM	Opposite	
Architect	ARCH	Partition	F
Average	AVG	Plate	
Beam	BM BRD	Plastic laminate	PLI
Board Brase	BRD BRD	Pluming	P
Bronze	BRZ	Plywood Quantity	(
Building	BLDG	Quarry title	
Cabinet	CAB	Radius	R or R
Ceiling	CLG	Reference	F
Center line	CL	Reinforce	RE
Centimeter	CM	Remove	F
Ceramic Clear	CER CLR	Required Revision	RI
Cold Water	CW	Revision	F
Column	COL	Specification	SI
Concrete	CONC	Square	O.
Concrete Masonry Unit	CMU	Rough	F
Construction	CONST	Schedule	,
Continuous	CONT	Section	S
Contractor	CONTR	Stainless steel	
Demolition	DEMO	Standard	) ( )
Detail	DET	Steel	ST or
Diameter Dimension	DIA DIM	Structural Suspended	5
Dimension Door	DR	System	
Down	DN	Telephone	<u>`</u>
Drawing	DWG	Temperature	T
Drinking fountain	DF	Tonge and grove	
Each	EA or Ea.	Tread	
Electric	ELEC	Typical	
Electric water	EWC	Unfinished	
Equal	EQL or EQ	Urinal	
Equipment Estimate	EQUIP EST	Vent through roof	
Existing	EXIST	Verify in the field  Vertical	V
Exterior	EXT	Vinyl tile	VTILE 0
Fabricate	FAB	Wainscot	VIILLO
Feet	FT.	Water closet	
Finish	FIN	Water proof	WP or WTR
Finished	FIND	Weight	
Fireproof	FP	Width	
Floor	FL FLUOR	With	
Fluoresent Full size	FLOOR	Without Wood	
Furnished	FURN	Wrought iron	
Gauge	GA	Woodgittiioii	
Gauge General	GEN		
Glass	GL		
Floor Drain	F.D.		
Gypsum board	GYPBD		
Hardware	HDW		
Hardwood	HDWD		
Height	HT or HGT		
Hollow core Horizontal Inch	HC HOR or HORIZ		
Horizontal Inch Hot water Insulation	HW		
nterior	INT		
Junction box	J-BOX ORJB		
Lavatory	LAV		
Light	LT		
Lighting	LTG		
Linear	L		
Manufacture	MFR		
Manufactured Marble	MFD MAR		
Masonry	MAR MAS		
Masonry opening	MO		
Material			
Maximum	MTL MAX		
Mechanical	MECH		
Meter	M		
Minimum	MIN		
Miscellaneous	MISC		
Mullion	MULL		
Natural	NAT		
Nominal	NOM		
Not in contract	NIC		
Not to scale	NIS		
Number	NO or #		

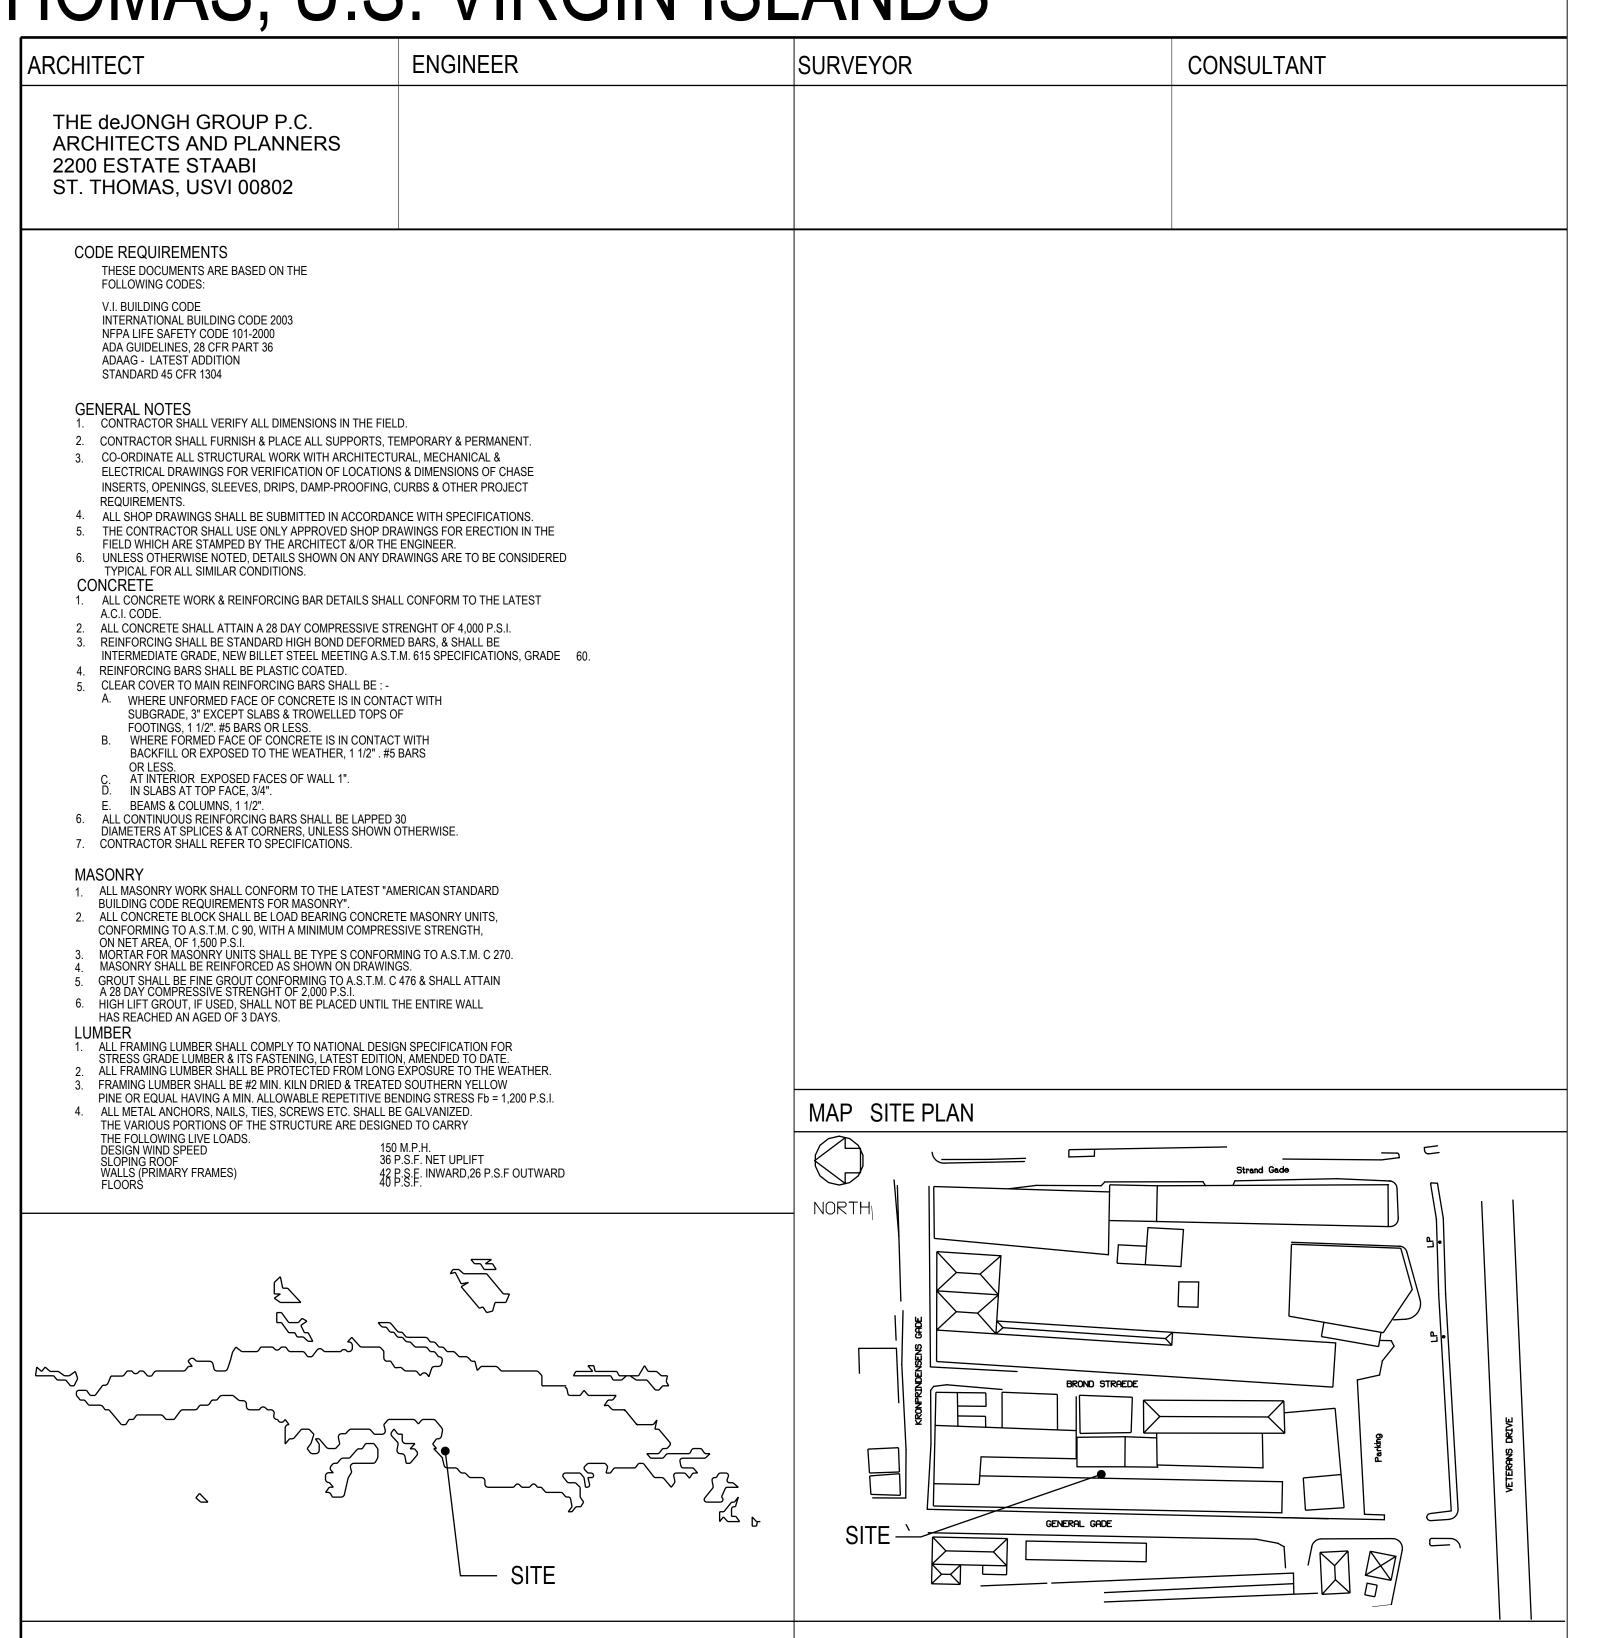

ST THOMAS MAP SITE LOCATION

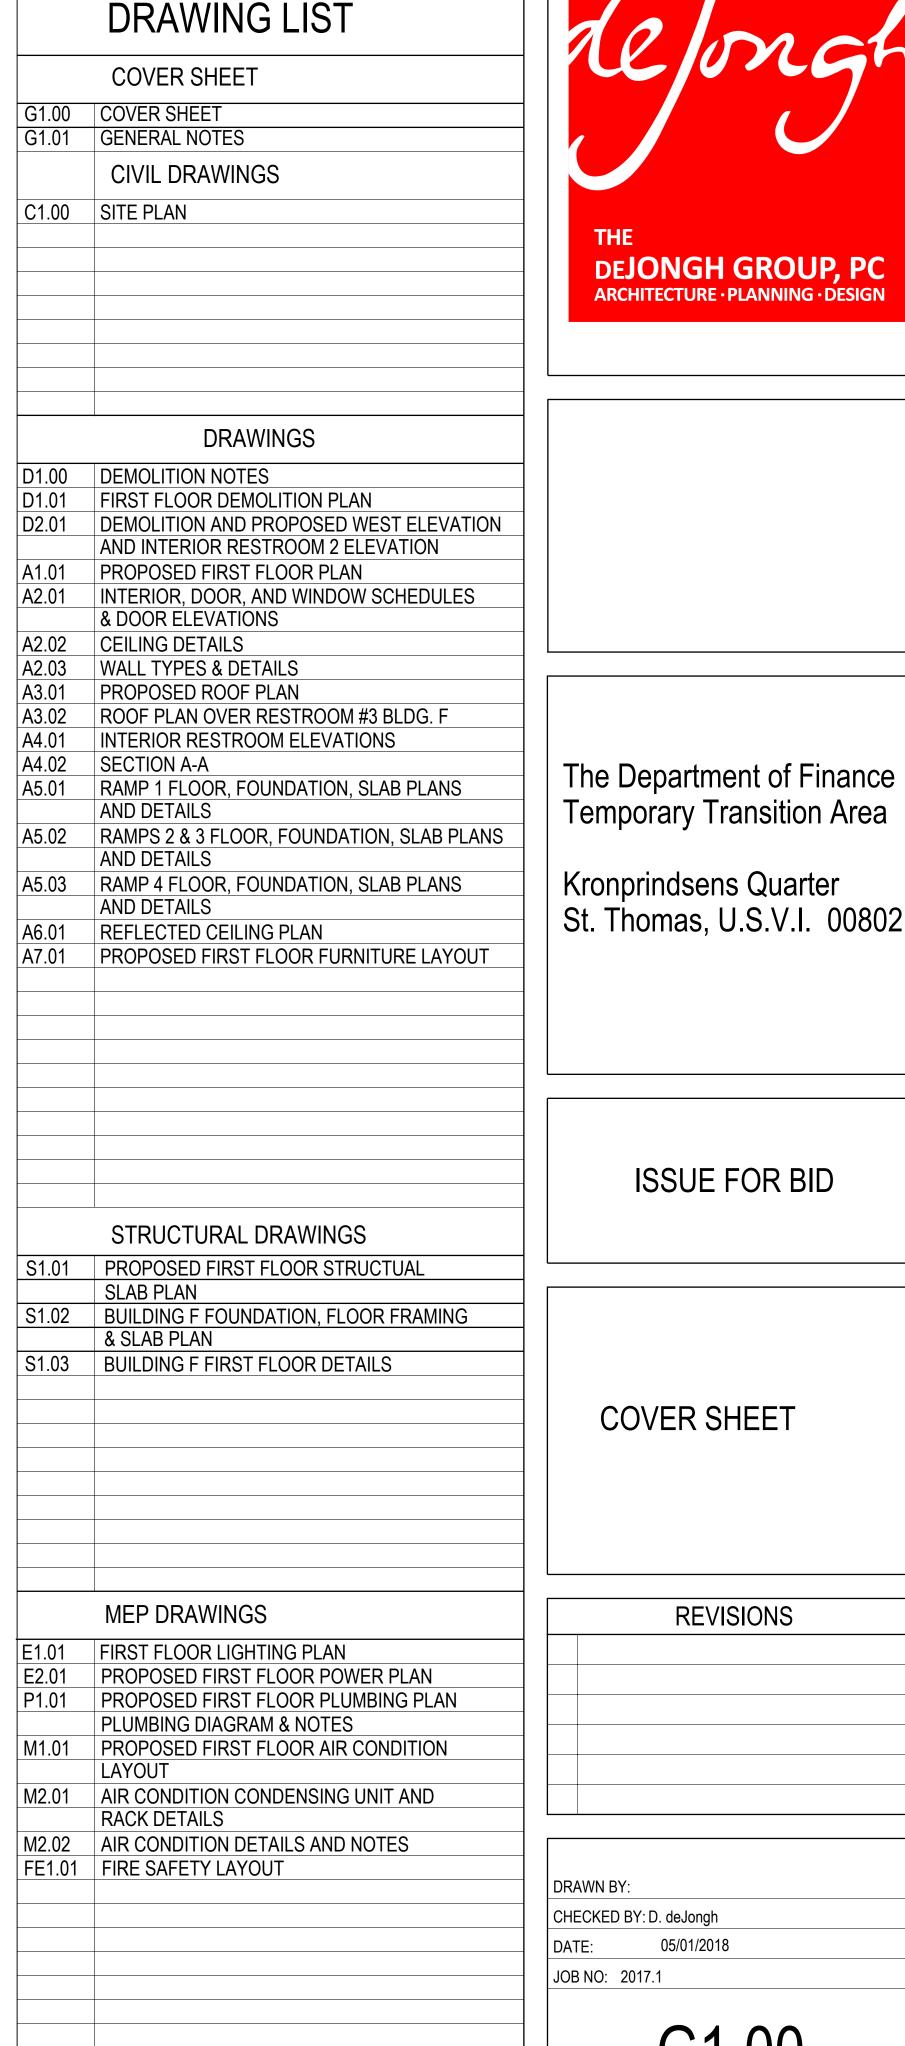

## GENERAL NOTES

#### A. GENERAL:

- I. ALL CONSTRUCTION SHALL CONFORM TO THE 2012 INTERNATIONAL BUILDING CODE UNLESS MORE STRINGENT REQUIREMENTS ARE REQUIRED IN THE PLANS AND SPECIFICATIONS.
- 2. THE CONTRACTOR SHALL VERIFY IN THE FIELD ALL CONDITIONS, ELEVATIONS AND DIMENSIONS BEFORE STARTING WORK. THE ARCHITECT AND ENGINEER SHALL BE NOTIFIED IMMEDIATELY IF ANY DISCREPANCIES ARE FOUND.
- 3. THE CONTRACTOR SHALL INFORM THE ARCHITECT AND ENGINEER IN WRITING OF ANY DISCREPANCIES OR OMISSIONS NOTED ON THE DRAWINGS OR IN THE SPECIFICATIONS OR OF ANY VARIATIONS NEEDED IN ORDER TO CONFORM TO CODES, RULES AND REGULATIONS. UPON RECEIPT OF SUCH INFORMATION, THE ENGINEER WILL SEND WRITTEN INSTRUCTIONS TO ALL CONCERNED. AND WORK SHALL BE PERFORMED IN A MANNER AS DIRECTED BY THE ENGINEER. ANY SUCH DISCREPANCY, OMISSION, OR VARIATION NOT REPORTED. SHALL BE THE RESPONSIBILITY OF THE CONTRACTOR.
- 4. THE CONTRACT DOCUMENTS REPRESENT THE FINISHED STRUCTURE. THEY DO NOT INDICATE METHOD OF CONSTRUCTION.
- 5. IT SHALL BE THE RESPONSIBILITY OF THE CONTRACTOR TO PROVIDE TEMPORARY BRACES, SHORES AND GUYS, WHEREVER NECESSARY TO SUPPORT ALL LOADS TO WHICH THE STRUCTURE MAY BE SUBJECTED DURING CONSTRUCTION, INCLUDING ERECTION OF EQUIPMENT AND ITS OPERATION. THIS TEMPORARY SUPPORT SYSTEM SHALL HOLD ALL ELEMENTS AND MEMBERS IN THEIR FINAL POSITION UNTIL TOTALLY AND FINALLY CONNECTED TO THE PERMANENT BRACING ELEMENTS.
- 6. THE TYPICAL NOTES AND DETAILS SHALL APPLY IN ALL CASES UNLESS SPECIFIC DETAILS OCCUR ELSEWHERE. WHERE NO DETAIL IS SHOWN, CONSTRUCTION SHALL BE AS FOR SIMILAR WORK.
- . REQUIRED INSPECTIONS BY VIRGIN ISLANDS DEPARTMENT OF PLANNING AND NATURAL RESOURCES (BUILDING DEPARTMENT):
- a. FOUNDATIONS
- b. CONCRETE
- c. MASONRY

#### B. CONCRETE:

- I. CONCRETE WORK SHALL BE IN ACCORDANCE WITH AMERICAN CONCRETE INSTIITUTE (ACI) - BUILDING CODE REQUIREMENTS FOR REINFORCED CONCRETE (ÁCI 318- LATEST REVSION).
- 2. CONCRETE SHALL HAVE A MINIMUM COMPRESSIVE STRENGTH AFTER 28 DAYS EQUAL TO OR GREATER THAN 4.000 PSI.
- 3. CONTINUOUS INSPECTION REQUIRED FOR ALL CONCRETE. INSPECTION BY BUILDING INSPECTOR REQUIRED FOR PLACEMENT OF REINFORCING STEEL PRIOR TO PLACING CONCRETE. CONTINUOUS INSPECTION IS NOT REQUIRED DURING PLACING CONCRETE OR REINFORCING.
- 4. ALL CONCRETE SHALL BE NORMAL WEIGHT (145 PCF) UNLESS NOTED AS LIGHTWEIGHT CONCRETE.
- 5. PORTLAND CEMENT: ASTM C150, TYPE I OR TYPE II, LOW ALKALI.
- 6. CONCRETE AGGREGATE SHALL CONFORM TO ASTM C33 WITH THE FOLLOWING NOMINAL LIMITATIONS:
- a. FOOTINGS AND SLABS ON GRADE, 1 TO 1-1/4 INCH MAXIMUM. b. WALLS AND STRUCTURAL SLABS, 3/4 INCH MAXIMUM.
- 7. CONCRETE STRENGTH MIX DESIGN SHALL BE DOCUMENTED BY NEW OR EXISTING TEST REPORTS FROM APPROVED LICENSED TESTING LABORATORIES PRIOR TO BATCHING.
- 8. EXPOSED CONCRETE FORMING AND FINISH SHALL BE AS NOTED ON ARCHITECTURAL DRAWINGS. SEE ARCHITECTURAL DRAWINGS FOR DETAILS.
- 9. PROJECTING CORNERS OF BEAMS, COLUMNS, ETC. SHALL BE FORMED WITH 3/4 INCH CHAMFER, UNLESS OTHERWISE DETAILED.
- 10. FORMS FOR CONCRETE SHALL BE LAID OUT AND CONSTRUCTED TO PROVIDE THE SPECIFIED CHAMBERS SHOWN ON THE DRAWINGS.
- 11. SHORING OF STRUCTURAL SLABS:
- a. ALL SHORING AND RESHORING SHALL BE DONE IN ACCORDANCE WITH ACI STANDARD RECOMMENDED PRACTICE FOR CONCRETE FORMWORK (ACI - 347).
- b. ONE HUNDRED PÉRCENT SHORING AND FORMS SHALL REMAIN IN PLACE FOR 14 DAYS MINIMUM. SHORING MAY BE REDUCED TO 50 PERCENT AFTER 14 DAYS, PROVIDED CONCRETE STRENGTH EQUALS AT LEAST 75 PERCENT OF DESIGN STRENGTH.
- c. RESHORES SHALL NOT BE REMOVED IF CONCRETE STRENGTH DOES NOT MEET SPECIFIED STRENGTH AT 28 DAYS. d. NEWLY PLACED SLABS SHALL NOT BE USED TO SUPPORT SLABS ABOVE UNTIL THE LOWER SLAB HAS CURED FOR 5 DAYS, MINIMUM.
- SHORING TO SUPPORT UPPER LEVEL SLAB MAY BE PLACED WITHIN THE 5 DAY CURING PERIOD.
- 12. CONTRACTOR SHALL REFER TO SPECIFICATIONS.

#### C. MASONRY:

- 1. CONCRETE BLOCK MASONRY UNITS: ASTM C90. UNIT AREA STRENGHT F'm = 1900 PSI, MEDIUM WEIGHT. MASONRY UNIT COLOR AND FACE TEXTURE AS NOTED ON ARCHITECTURAL DRAWINGS. DESIGN STRENGHT f'm = 1500 PSI.
- 2. MASONRY UNIT SHALL HAVE BEEN CURED FOR NOT LESS THAN 28 DAYS AND SHALL BE CLIMATIZED TO SITE BEFORE PLACED IN BUILDING.
- 3. CONTINUOUS INSPECTION IS REQUIRED, UNLESS NOTED OTHERWISE.
- a. PREPARATION AND FORMING OF WALL PRISMS. b. SAMPLING AND PLACING OF MASONRY UNITS.
- c. PLACEMENT OF REINFORCEMENT.
- d. GROUT SPACE IMMEDIATELY PRIOR TO CLOSING OF CLEANOUTS AND DURING ALL GROUTING OPERATIONS.
- 4. ALL MORTAR AND GROUT SHALL HAVE A MINIMUM 28 DAYS COMPRESSIVE STRENGTH EQUAL TO 1800 PSI AND 2000 PSI, RESPECTIVELY. ADMIXTURES WHEN USED SHALL BE PER MANUFACTURER'S RECOMMENDATION AND WITH APPROVAL OF THE BUILDING OFFICIAL.
- 5. PORTLAND CEMENT ASTM C150, TYPE II, LOW ALKALI.
- 6. MORTAR MIX 1:3 WITH 1/4 PART LIME PUTTY. TYPE S.
- 7. GROUT MIX 1:3 WITH 2 PARTS PEA GRAVEL.
- 8. GROUT REQUIREMENTS:
- a. GROUT MIX SHALL BE IN ACCORDANCE WITH IBC STANDARDS.
- 9. GROUT ALL CELLS, UNLESS OTHERWISE NOTED.
- 10. USE BOND BEAM UNITS AT HORIZONTAL REINFORCING.
- 11. LOCATE REBARS ABOUT CENTERLINE OF MASONRY WALL UNLESS DETAILED OTHERWISE.
- 12. ALL WALLS SHALL BE CONSTRUCTED USING 1/2 RUNNING BOND BETWEEN MASONRY. UNLESS OTHERWISE NOTED.
- 13. ALL WOOD PLATES TO BE BOLTED TO THE TOP OF MASONRY WALLS SHALL BE SET ON A MORTAR BED, TO PROVIDE UNIFORM BEARING.

#### D. REINFORCING STEEL FOR CONCRETE AND MASONRY:

- 1. REINFORCING BARS: ASTM A615, GRADE 60. ALL REINFORCING STEEL THAT IS TO BE WELDED SHALL CONFORM TO ASTM A706. UNLESS OTHERWISE NOTED ON PLANS.
- 2. WELDED WIRE FABRIC: ASTM A185.
- 3. WELDING ELECTRODES: AWS D1.4, CLASS E90, LOW HYDROGEN.
- 4. MINIMUM SPLICE LENGTHS, UNLESS DETAILED OTHERWISE:
- a. CONCRETE SEE SCHEDULE ON DRAWING.
- b. MASONRY SEE SCHEDULE ON DRAWING. c. WELDED WIRE FABRIC SHALL BE SPLICED WITH A MINIMUM LAP OF 12 INCHES.
- 5. MINIMUM CLEARANCE BETWEEN REINFORCING AND FACE OF CONCRETE SHALL BE AS FOLLOWS (UNLESS SHOWN OTHERWISE):
- a. CONCRETE BELOW GRADE (CAST AGAINST SOIL) = 3"
- b. CONCRETE BELOW GRADE (FORMED) = 2" c. CONCRETE WALLS EXPOSED TO WEATHER = 2"
- d. CONCRETE WALLS, INTERIOR WALLS = 2"
- e. CONCRETE SLAB (STRUCTURAL) = 2"
- f. CONCRETE BEAMS AND COLUMNS = 2"
- 6. SPLICES IN COLUMNS AND BEAMS SHALL OCCUR ONLY WHERE DETAILED. SPLICES IN CONTINUOUS GRADE BEAMS SHALL OCCUR AT 1/3 SPAN. CONTACT STRUCTURAL ENGINEER IF CLARIFICATION IS NEEDED.
- 7. SPLICES IN HORIZONTAL WALL REINFORCEMENT SHALL BE STAGGERED 3'-0" MINIMUM FROM SPLICE CENTERLINE. WHERE WALLS HAVE TWO LAYERS OF REINFORCING. SPLICES SHALL NOT OCCUR IN THE SAME LOCATION.
- 8. ALL REINFORCING SHALL BE ACCURATELY PLACED AND ADEQUATELY SUPPORTED BEFORE CONCRETE IS PLACED AND SHALL BE SECURED AGAINST DISPLACEMENT WITHIN PERMITTED TOLERANCE. CLEARANCE FOR REBAR SHALL BE SHOWN IN DETAIL OR CALLED IN NOTES. TOLERANCE SHALL BE AS PER ACI 318.
- 9. PROVIDE SLEEVES FOR PLUMBING MECHANICAL AND ELECTRICAL OPENINGS IN THE CONCRETE MEMBERS BEFORE PLACING CONCRETE. DO NOT CUT ANY REINFORCING WHICH MAY CONFLICT. CORING IN CONCRETE IS NOT PERMITTED EXCEPT WHERE SHOWN ON DRAWINGS OR APPROVED BY THE STRUCTURAL ENGINEER.

- E. NON-SHRINK GROUT OR DRYPACK:
- 1. NON-SHRINK GROUT OR DRYPACK SHALL CONSIST OF A PREMIXED NON-METALLIC FORMULA.
- 2. MINIMUM FORMULA REQUIREMENTS.
- a. NO SHRINKAGE AFTER PLACEMENT.
- b. NO EXPANSION AFTER SET (ASTM C-827).
- c. INITIAL SET UP TIME NOT LÈSS THAN 45 MINUTES (ASTM C-1911). d. ONE DAY COMPRESSIVE STRENGTH = 3000 PSI (ASTM C-109).
- e. f'c AT 28 DAYS = 5000 PSI.

#### F. LUMBER:

- 1. ALL LUMBER SHALL BE SOUTHERN YELLOW PINE, GRADE #1 -PRESSURE TREATED. UNLESS OTHERWISE NOTED.
- 2. ALL FRAMING LUMBER SHALL BE S4S. LUMBER DESIGN BASED ON ANSI/NFoPA NDS - 1991 - NATIONAL DESIGN STANDARDS.
- 3. PLYWOOD SHEATHING PRESSURE TREATED (U.S. PS1-83) WITH EXTERIOR GLUE AND APA RATED.
- 4. ALL NAILING SHALL BE IN ACCORDANCE WITH IBC REQUIRMENTS UNLESS NOTED OTHERWISE ON THE DRAWINGS. USE COMMON WIRE NAILS. NAILING OF ROOF, FLOOR AND SHEARWALL SHEATHING SHALL BE INSPECTED AND APPROVED BY THE BUILDING DEPARTMENT BEFORE COVERING.USEONLY ACQ APPROVED CONNECTORS
- 5. BOLTS SHALL COMPLY WITH ASTM A-307, BOLT HOLES IN WOOD SHALL BE 1/16 INCH MAXIMUM OVERSIZE. ALL BOLT HEAD AND NUTS BEARING ON WOOD SHALL HAVE STEEL WASHERS.
- 6. NO LENGTH OF SPLIT IN MEMBER SHALL EXCEED THE WIDTH OF THE MINOR FACE.
- 7. CONNECTOR DESIGNATIONS REFER TO STRONG-TIE CONNECTORS BY SIMPSON COMPANY. ALL CONNECTORS TO BE INSTALLED ACCORDING TO MANUFACTURER'S INSTRUCTIONS.
- 8. ANY HOLE THROUGH STRUCTURAL MEMBERS FOR PIPES OR CONDUIT SHALL BE VERIFIED WITH THE STRUCTURAL ENGINEER.
- 9. NAIL ALL 2X DOUBLE JOIST WITH 16d NAILS AT 9 INCH ON CENTER. STAGGERED.
- 10. PROVIDE DOUBLE JOIST UNDER ALL PARALLEL PARTITIONS.
- 11. FOR SIZE AND LOCATION OF ROOF, FLOOR AND WALL OPENINGS. SEE ARCHITECTURAL, MECHANICAL AND ELECTRICAL DRAWINGS, FRAME ALL FOUR SIDES OF OPENING WITH ADEQUATE MEMBERS AND CONNECTORS.
- 12. PROVIDE DOUBLE STUDS UNDER ALL BEAM ENDS UNLESS NOTED OTHERWISE AND CARRY STUDS DOWN TO FOUNDATION.

CONTRACTOR SHALL VERIFY ALL SITE DIMENSIONS IN THE FIELD

#### SYMBOLS LEGEND



NEW CONCRETE SLAB



EXISTING CONCRETE SLAB



The Department of Finance **Temporary Transition Area** 

Kronprindsens Quarter St. Thomas, U.S.V.I. 00802

ISSUE FOR BID

GENERAL NOTES

**REVISIONS** 

DRAWN BY CHECKED BY: D. deJongh 05/01/2018

DATE: JOB NO: 2017.1

G1.01

#### A. GENERAL: F. LUMBER: 1. ALL CONSTRUCTION SHALL CONFORM TO THE 2012 INTERNATIONAL 1. ALL LUMBER SHALL BE SOUTHERN YELLOW PINE, GRADE #1 -BUILDING CODE UNLESS MORE STRINGENT REQUIREMENTS ARE PRESSURE TREATED, UNLESS OTHERWISE NOTED. REQUIRED IN THE PLANS AND SPECIFICATIONS. 2. ALL FRAMING LUMBER SHALL BE S4S. LUMBER DESIGN BASED ON ANSI/NFOPA NDS - 1991 - NATIONAL DESIGN STANDARDS. 2. THE CONTRACTOR SHALL VERIFY IN THE FIELD ALL CONDITIONS, ELEVATIONS AND DIMENSIONS BEFORE STARTING WORK. THE ARCHITECT AND STRUCTURAL ENGINEER SHALL BE NOTIFIED 3. PLYWOOD SHEATHING - PRESSURE TREATED (U.S. PS1-83) WITH IMMEDIATELY IF ANY DISCREPANCIES ARE FOUND. EXTERIOR GLUE AND APA RATED. 3. THE CONTRACTOR SHALL INFORM THE ENGINEER IN WRITTING OF 4. ALL NAILING SHALL BE IN ACCORDANCE WITH IBC REQUIRMENTS ANY DISCREPANCIES OR OMISSIONS NOTED ON THE DRAWINGS OR IN UNLESS NOTED OTHERWISE ON THE DRAWINGS. USE COMMON WIRE NAILS. NAILING OF ROOF, FLOOR AND SHEARWALL SHEATHING SHALL THE SPECIFIFCATIONS OR OF ANY VARIATIONS NEEDED IN ORDER TO DEJONGH GROUP, PC CONFORM TO CODES, RULES AND REGULATIONS. UPON RECEIPT OF SUCH BE INSPECTED AND APPROVED BY THE BUILDING DEPARTMENT BEFORE ARCHITECTURE • PLANNING • DESIGN INFORMATION, THE ENGINEER WILL SEND WRITTEN INSTRUCTIONS TO COVERING.USE ONLY ACQ APPROVED CONNECTORS ALL CONCERNED, AND WORK SHALL BE PERFORMED IN A MANNER AS 5. BOLTS SHALL COMPLY WITH ASTM A-307, BOLT HOLES IN WOOD DIRECTED BY THE ENGINEER. ANY SUCH DISCREPANCY, OMISSION, OR VARIATION NOT REPORTED, SHALL BE THE RESPONSIBILITY OF THE SHALL BE 1/16 INCH MAXIMUM OVERSIZE. ALL BOLT HEAD AND NUTS CONTRACTOR. BEARING ON WOOD SHALL HAVE STEEL WASHERS. 4. THE CONTRACT DOCUMENTS REPRESENT THE FINISH STRUCTURE. 6. NO LENGTH OF SPLIT IN MEMBER SHALL EXCEED THE WIDTH OF THEY DO NOT INDICATE METHOD OF CONSTRUCTION. THE MINOR FACE. 5. IT SHALL BE THE RESPONSIBILLITY OF THE CONTRACTOR TO 7. CONNECTOR DESIGNATIONS REFER TO STRONG-TIE CONNECTORS BY SIMPSON COMPANY. ALL CONNECTORS TO BE INSTALLED ACCORDING TO PROVIDE TEMPORARY BRACES, SHORES AND GUYS, WHEREVER NECESSARY TO SUPPORT ALL LOADS TO WHICH THE STRUCTURE MAY MANUFACTURER'S INSTRUCTIONS. BE SUBJECTED DURING CONSTUCTION, INCLUDING ERECTION EQUIPMENT AND ITS OPERATION. THIS TEMPORARY SUPPORT SYSTEM 8. ANY HOLE THROUGH STRUCTURAL MEMBERS FOR PIPES OR CONDUIT SHALL HOLD ALL ELEMENTS AND MEMBERS IN THEIR FINAL POSITION SHALL BE VERIFIED WITH THE STRUCTURAL ENGINEER. UNTIL TOTALLY AND FINALLY CONNECTED TO THE PERMANENT BRACING ELEMENTS. 9. NAIL ALL 2X DOUBLE JOIST WITH 16d NAILS AT 9 INCH ON CENTER, STAGGERED AS A MINIMUM. 6. THE TYPICAL NOTES AND DETAILS SHALL APPLY IN ALL CASES 10. PROVIDE DOUBLE JOIST UNDER ALL PARALLEL PARTITIONS. UNLESS SPECIFIC DETAILS OCCUR ELSEWHERE. WHERE NO DETAIL IS SHOWN, CONSTRUCTION SHALL BE AS FOR SIMILAR WORK. 11. FOR SIZE AND LOCATION OF ROOF, FLOOR AND WALL OPENINGS, 7. REQUIRED INSPECTIONS BY VIRGIN ISLANDS DEPARTMENT OF SEE ARCHITECTURAL, MECHANICAL AND ELECTRICAL DRAWINGS. FRAME PLANNING AND NATURAL RESOURCES (BUILDING DEPARTMENT): ALL FOUR SIDES OF OPENING WITH ADEQUATE MEMBERS AND CONNECTORS. a. FOUNDATIONS The Department of Finance b. CONCRETE 12. PROVIDE DOUBLE STUDS UNDER ALL BEAM ENDS UNLESS NOTED c. MASONRY OTHERWISE AND CARRY STUDS DOWN TO FOUNDATION. Temporary Transition Area Kronprindsens Quarter 2 GENERAL NOTES St. Thomas, U.S.V.I. 00802 NO TO SCALE EXISTING FENCE TO REMAIN EXISTING TREE TO BE REMOVED ISSUE FOR BID WROUGHT **IRON GATE** NORTH **BUILDING "E"** ISLAND FAIR DEPARTMENT STORE AREA OF RENOVATION SITE PLAN GADE KRONPRINDSENS **BUILDING "D" BUILDING "A" BUILDING "F"** EXIST<del>ING</del> PARKING **REVISIONS** AREA OF RENOVATION **BUILDING "A"** DRAWN BY CHECKED BY: D. deJongh 05/01/2018 JOB NO: 2017.1 GENERAL GADE SITE PLAN C1.00 SCALE: 1/16" = 1'-0"

GENERAL NOTES

# GENERAL NOTES

No. 1& 2 OF DEMOLITION NOTES ARE APPLICABLE TO ALL DRAWING SHEETS.

PRIOR TO ALL DEMOLITION WORK IDENTIFY & LABEL ALL MECHANICAL, ELECTRICAL, AND PLUMBING COMPONENTS AND FUNCTIONS. PROVIDE GRAPHIC SCHEMATIC DIAGRAM SHOWING CIRCUITRY OF ELECTRICAL COMPONENTS TO REMAIN BOTH THE: ORIGIN & RESPECTIVE PANEL TO WHICH THEY RELATE. ALL ELECTRICAL DEMOLITION TO BE PERFORMED BY A QUALIFIED PROFESSIONAL CONTRACTOR LICENSED IN THE U.S. VIRGIN ISLANDS.

# DEMOLITION NOTES

- CONTRACTOR SHALL VISIT AND EXAMINE THE SITE & STRUCTURE TO VERIFY ALL QUANTITIES AND EXISTING CONDITIONS TO BE REMOVED.

  REMOVE ALL DEBRIS FROM CONSTRUCTION SITE
- REMOVE ALL DEBRIS FROM CONSTRUCTION SITE AND DISPOSE OF DEBRIS IN A MANNER AS PER VI
- REMOVE ALL EXISTING WINDOWS AS NOTED. SEE WINDOW SCHEDULE FOR NEW WORK.
- REMOVE PAINT AND RECONDITION ALL WALLS TO REMIAN IN PREPARATION OF NEW PAINT.
- REMOVE EXISTING BI FOLD DOORS AND REPAIR FRAME AS REQUIRED AS PER PROPOSED FLOOR PLAN.
- SCRAPE PATCH AND REPAIR EXTERIOR MASS
  MASONRY WALL TO RECEIVE NEW HIGH PERFORMANCE
- REMOVE ALL EXISITING WALL BOARDS
  ATTACHED TO WALLS. THIS SHALL INCLUDE BUT
  IS NOT LIMITED TO THE REMOVAL OF ALL WOOD
  CASED OPENINGS, DOORS, FRAMES AND TRIM,
  WOOD BASE, WINDOW TRIM ETC.. CHECK EXISTING
  WALL FRAMING FOR INSECTS, WATER, EVIDENCE OF
  MOLD AND OTHER DAMAGE. SAFEGUARD ALL
  DOORS, FRAMES, & HARDWARE FOR POTENTIAL
  SALVAGE & REUSE IN OTHER LOCATIONS. REUSE
  TO BE DETERMINED BY ARCHITECT. SEE FLOOR
  PLAN FOR NEW WORK.

## DEMOLITION NOTES

- REMOVE ALL COMPROMISED ELECTRICAL WORK WHICH INCLUDES BUT IS NOT LIMITED TO ALL OUTLETS, SWITCHES, LIGHTS: CEILING AND WALL, EXIT SIGNS, EMERGENCY LIGHTS, PHONE OUTLETS, CEILING FANS, PANELS AND WIRING AND CEILING FANS. SEE ELECTRICAL DRAWINGS FOR NEW WORK.
- REMOVE EXISTING PLUMBING AND MECHANICAL EQUIPMENT WHICH INCLUDES BUT IS NOT LIMITED TO ALL PLUMBING FIXTURES AND PIPES: BOTH WATER, AND WASTE, VENT PIPES, MECHANICAL GRILLS AND DUCTWORK SUPPLY, RETURN AND EXHAUST, ALL MECHANICAL EQUIPMENT AND THERMOSTATS AS REQUIRED. SAFEGUARD ALL URINALS, WATER CLOSETS, SINKS BOTH: BATHROOM & KITCHEN AND RELATED COMPONENTS FOR POTENTIAL SALVAGE & REUSE IN OTHER LOCATIONS. REUSE TO BE DETERMINED BY ARCHITECT. SEE MECHANICAL AND PLUMBING DRAWINGS FOR NEW WORK.
- REMOVE EXSITING DOORS AND CONTRACTOR SHALL DISPOSE OR STORE AS PER THE ARCHITECT/ OWNERS
- REMOVE AND SAFEGUARD ALL CHAIRS, DESKS, CUBICLES & PARTITIONS IN THERE ENTIRETY. ALL CHAIRS, DESKS, CUBICLES & PARTITIONS TO BE STORED IN LOCATION DESIGNATED BY OWNER FOR POTENTIAL SALVAGE & REUSE IN OTHER LOCATIONS. REUSE TO BE DETERMINED BY OWNER.
- REMOVE ALL EXISTING PLUMBING FIXTURES AND PREPARE AREA TO RECEIVE NEW FIXTURES. STORE REMOVED FIXTURES FOR POTENTIAL SALVAGE & REUSE IN OTHER LOCATIONS. SEE FLOOR PLAN FOR PROPOSED WORK.

# DEMOLITION NOTES

- REMOVE EXISTING FLOOR AND WALL TILE
  IN RESTROOMS AND REPLACE ANY EXISTING
  SHEATHING WITH CEMENT BOARD AND PREPARE
  AREA TO RECEIVE NEW WALL TILE AND FLOOR TILE.
- CONTRACTOR TO VERIFY IF FLOOR DRAINS EXIST IF SO THEN SNAKE AND CLEAN OUT ALL EXISTING FLOOR DRAINS IN PREPARATION FOR NEW CONNECTIONS.
- WALLS AND FLOORS TO HAVE TRENCH TO PREPARE FOR NEW ELECTRICAL AND MECHANICAL CONDUIT (SEE PROPOSED PLAN)
- REMOVE EXISTING EXTERIOR DOOR AND PREPARE OPENING TO RECEIVE NEW WINDOW (SEE WINDOW SCHEDULE)
- REMOVE EXISTING PLANTER ON EXTERIOR EAST SIDE OF BUILDING AS NOTED

  RAMPS TO BE REMOVED AND RECONSTRUCTED TO COMPLY WITH ADA REGULATIONS.
- CONTRACTOR SHALL REMOVE ALL PARTITION COMPARTMENTS AND PLUMBING FIXTURES. RESTROOM TO BE RENOVATED IN COMPLIANCE WITH ADA REGULATIONS. COORDINATE NEW LAYOUT WITH EXISTING PLUMBING LINES.
- CONTRACTOR SHALL REMOVE ALL ACOUSTICAL CEILING TILE AND LIGHTING FIXTURES . REMOVE ALL POWER ASSOCIATED WITH THE DENOTED AREAS AND SET UP TEMPORARY POWER AS PER THE ARCHITECTS REQUEST IF AND PREPARE AREA FOR NEW POWER AND ELECTRICAL CONNECTIONS.
- REMOVE ALL COUNTERS SURFACES AND FRAMING THAT SUPPORTS IT.
- REMOVE EXISTING FLOORING MATERIAL AND PREPARE FLOOR FOR NEW ELEC. AND MECHANICAL TRENCH.AS DENOTED ON PROPOSED FLOOR PLAN.

# WALL DEMOLITION KEY

LINE TYPE	DESCRIPTION
	EXISTING TO REMAIN
	PATCH AND SCRAPE MASS MASONRY EXT. WALLS.
:::::::::::::::::::::::::::::::::::::::	REMOVE PARTITION DRYWALL AND FRAMING
	EXISTING WINDOW TO REMAIN
	EXISTING WINDOW TO BE REMOVED
	EXISTING DOOR TO REMAIN
de de la companya del companya de la companya del companya de la c	EXISTING DOOR TO BE REMOVED
	NEW WALL
	EXISTING COLUMN TO REMAIN

### PLUMBING DEMOLITION KEY

. 201112	on o bemoen for the
FIXTURE	DESCRIPTION
9 = = 0	URINAL
	WATER CLOSET
	LAVATORY SINK
0]0]	KITCHEN SINK

THE DEJONGH GROUP, PC ARCHITECTURE · PLANNING · DESIGN

The Department of Finance Temporary Transition Area

Kronprindsens Quarter St. Thomas, U.S.V.I. 00802

ISSUE FOR BID

**DEMOLITION NOTES** 

REVISIONS

DRAWN BY: O.C. & B.S.
CHECKED BY: D. deJongh

05/01/2018


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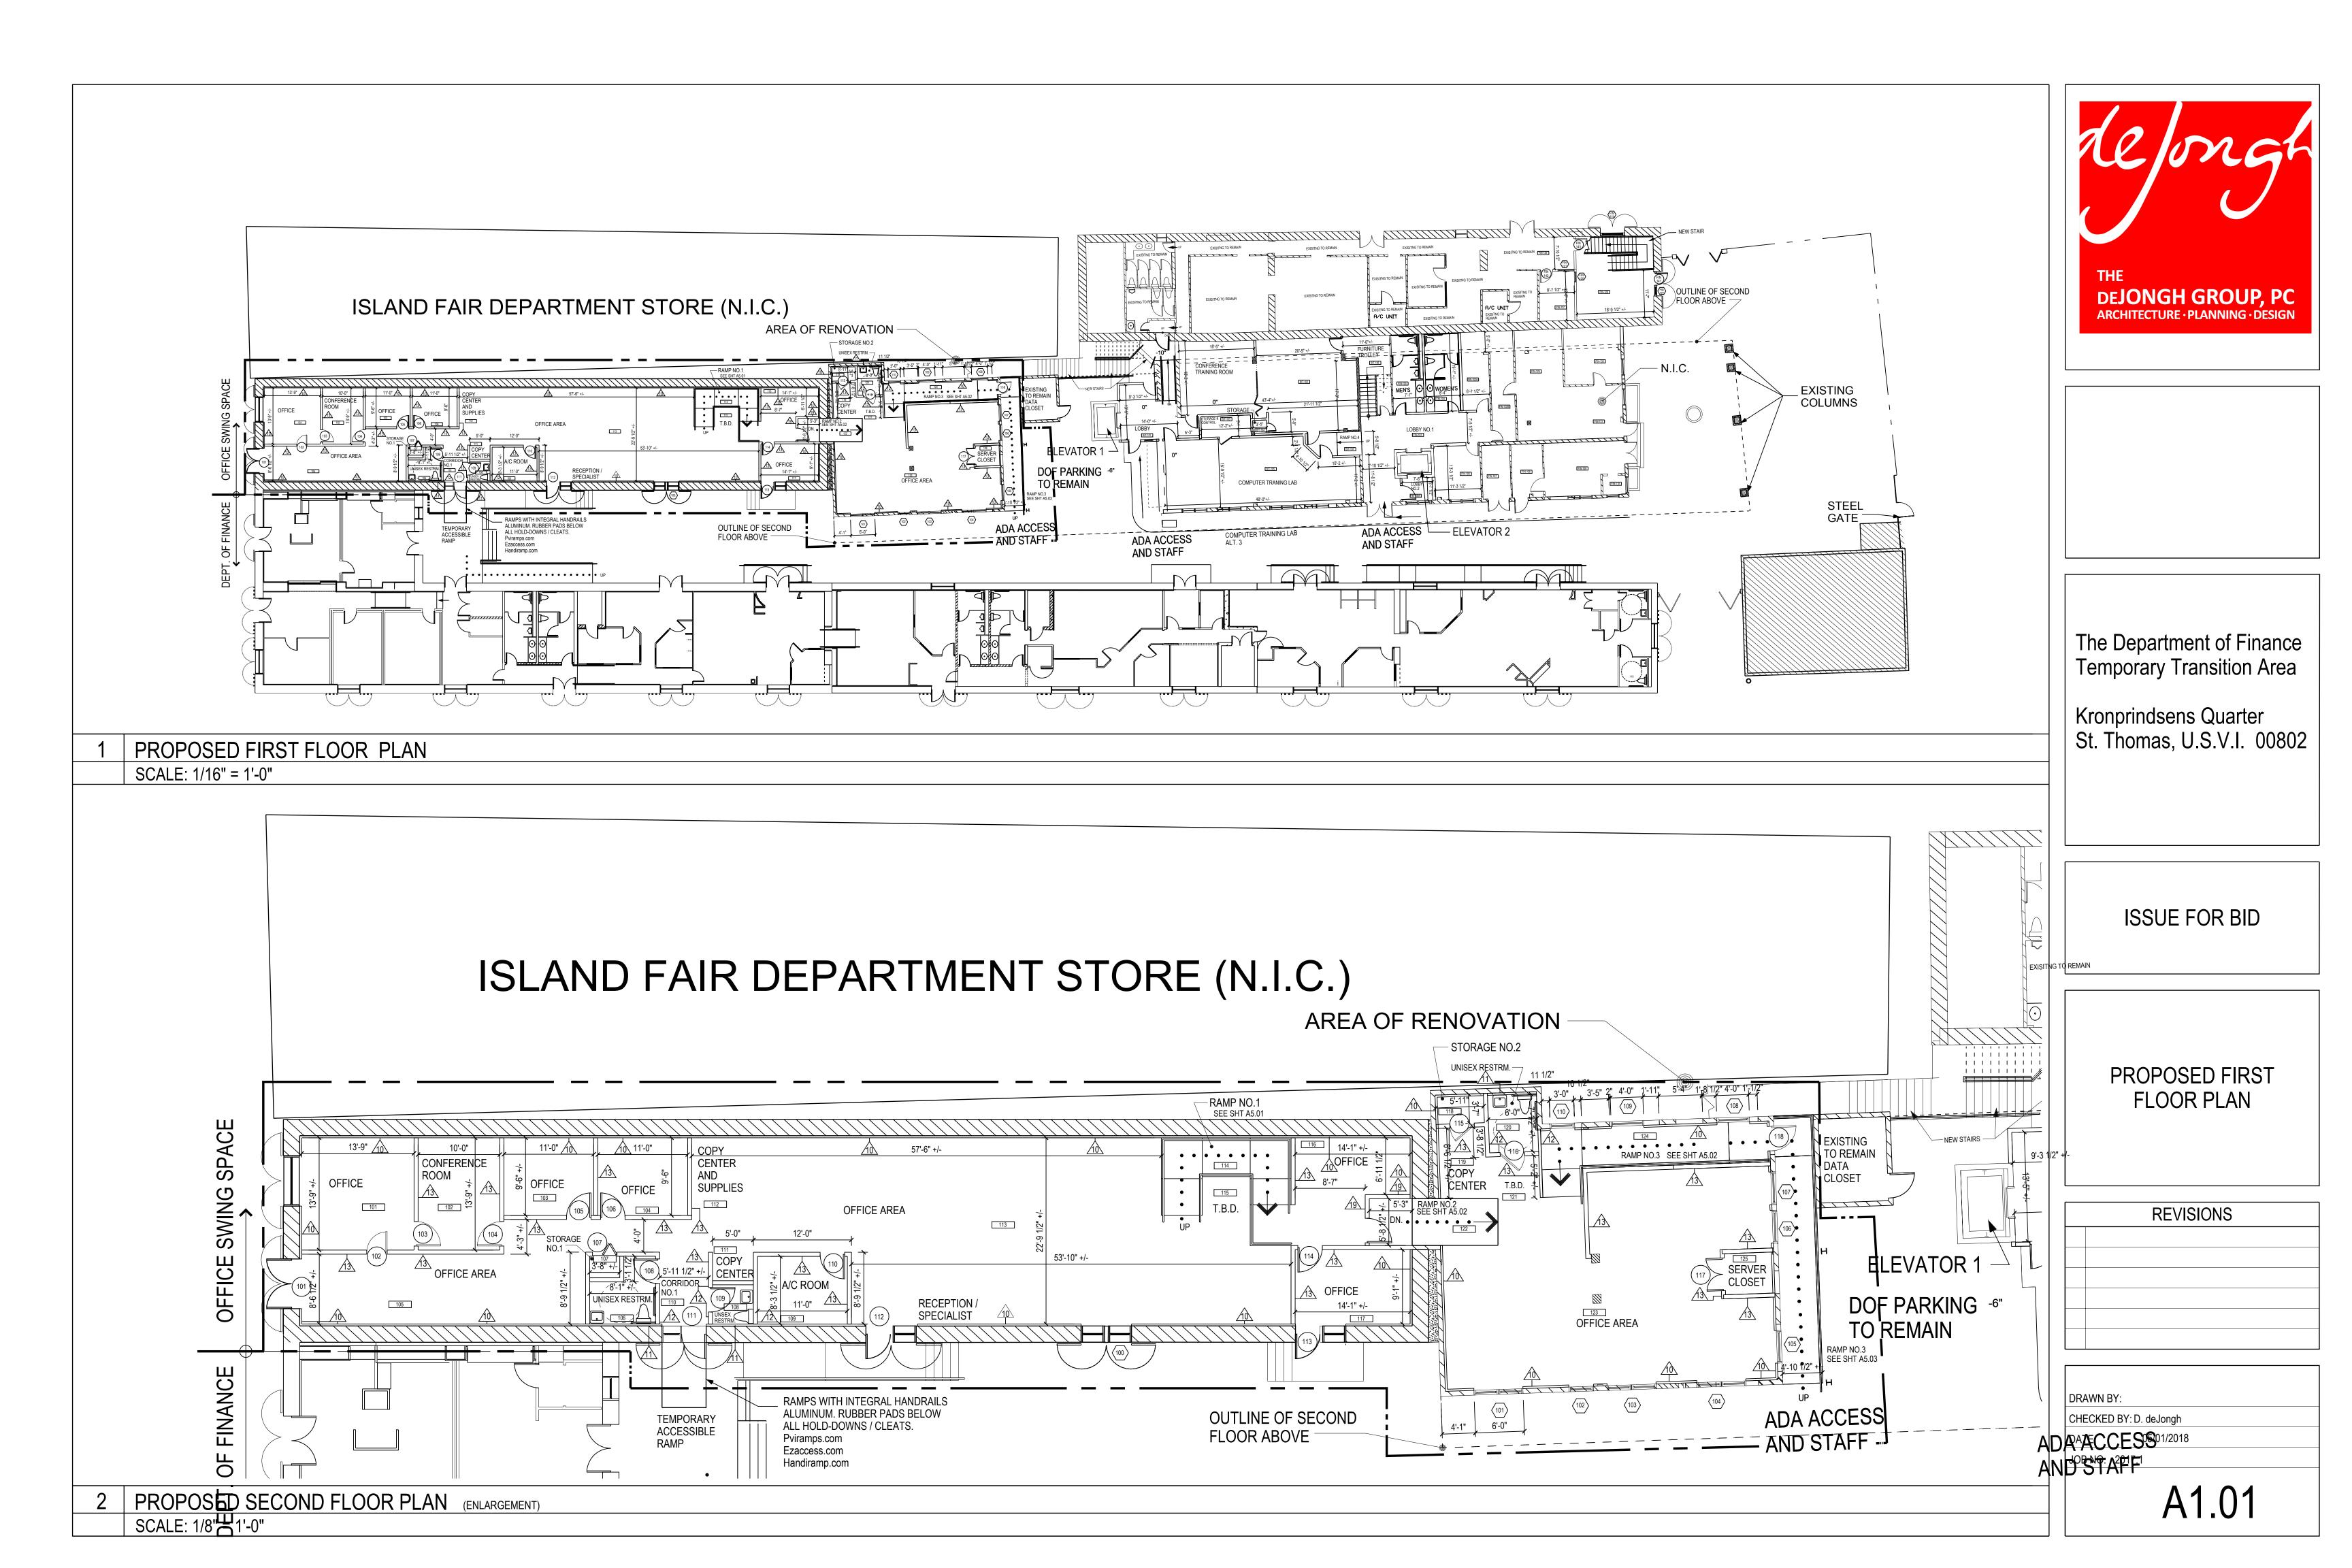
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DEMOLITION NOTES

NOT TO SCALE





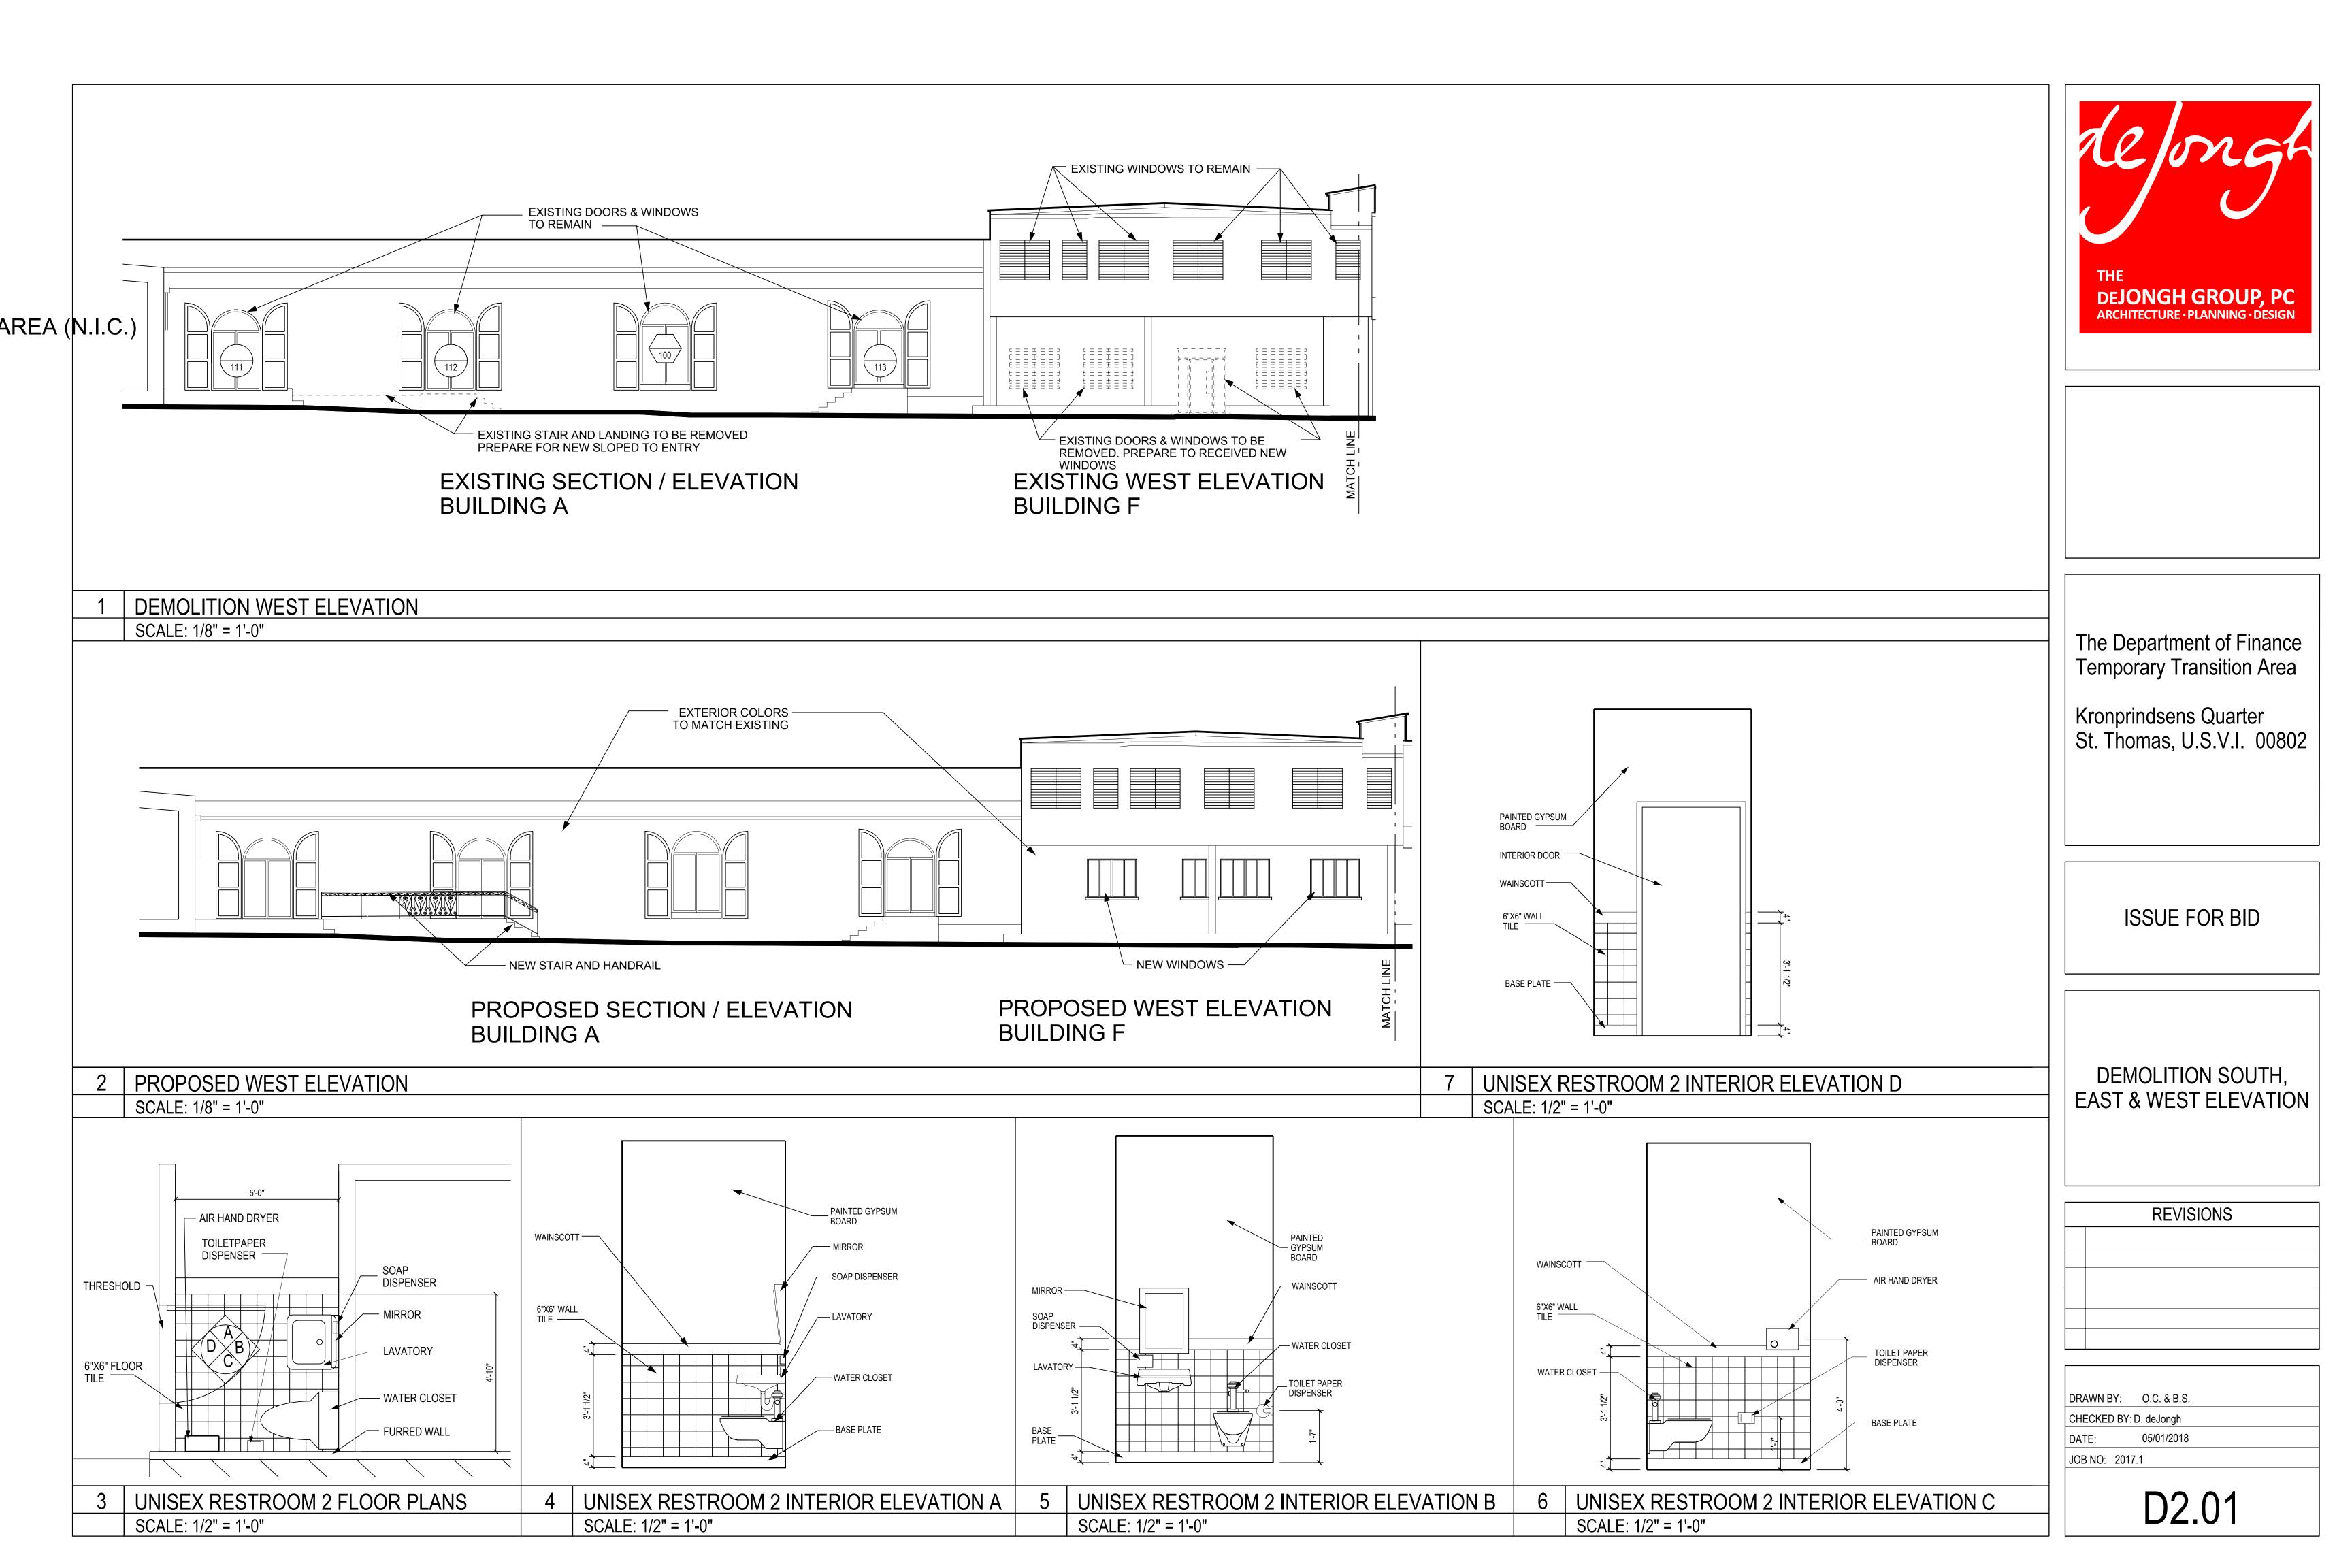

NO.   ROUM DESCRIPTION		DOOM DECODIDATION	FLOOR	חאפר	WAINS/	WALLS				CEILING		REMARKS
101	NO.	NO. ROOM DESCRIPTION FLOOR BASE	COAT	NORTH	EAST	SOUTH	WEST	MATERIAL	HGT.			
101												
102   CONFERENCE ROOM	101	OFFICE		PTD WOOD			G.W.B.	G.W.B.	G.W.B.	EXPOSED		
103	102	CONFERENCE ROOM	TILE	PTD WOOD		G.W.B.	G.W.B.	G.W.B.	G.W.B.	EXPOSED		
106	103	OFFICE	TILE	PTD WOOD		G.W.B.	G.W.B.	G.W.B.	G.W.B.	EXPOSED		
106	104	OFFICE	TILE	PTD WOOD		G.W.B.	G.W.B.	G.W.B.	G.W.B.	EXPOSED		
106	105	OFFICE	TILE			G.W.B.	G.W.B.	G.W.B.	G.W.B.	EXPOSED		
108	106	UNISEX ROOM	TILE	TILE		PTD. G.W.B.	PTD. G.W.B.	PTD. G.W.B.	PTD. G.W.B.	EXPOSED		
108	107	STORAGE	TILE		CEDANNO	G.W.B.	G.W.B.	G.W.B.	G.W.B.			
109	108	UNISEX ROOM	TILE			PTD. G.W.B.	PTD. G.W.B.	PTD. G.W.B.	PTD. G.W.B.			
110   CORRIDOR 1	109	A/C ROOM	TILE	PTD WOOD		G.W.B.	G.W.B.	G.W.B.	G.W.B.			
111	110	CORRIDOR 1	TILE			G.W.B.		G.W.B.	G.W.B.			
112   COPY CENTER AND SUPPLIES   TILE	111	COPY CENTER	TILE			G.W.B.	PAINTED	G.W.B.	G.W.B.		1	
113	112	COPY CENTER AND SUPPLIES	TILE			G.W.B.	G.W.B.	G.W.B.	G.W.B.			
TILE	113	OFFICE AREA	TILE		<del></del>	G.W.B.	G.W.B.	G.W.B.	G.W.B.			
TILE		RAMP NO.1	TILE			G.W.B.	G.W.B.	G.W.B.	G.W.B.			
TILE STORAGE TILE PTD WOOD TILE PTD WOOD TILE PAINTED			TILE			G.W.B.	G.W.B.	G.W.B.	G.W.B.			
TILE STORAGE  TILE PTD WOOD PAINTED PA	116			-								
TILE VINYL TILE PTD WOOD TO G.W.B. PAINTED PAIN							PAINTED					
120 UNISEX RESTROOM  CERAMIC TILE TILE TILE TILE TILE TILE TILE TILE			VINYL				PAINTED	PAINTED	PAINTED			
121 T.B.D. VINYL TILE PTD WOOD PAINTED			CERAMIC	CERAMIC	CERAMIC	CER. TILE/	CER. TILE/	CER. TILE/	CER. TILE/			
122 RAMP NO.2   TILE   PTD WOOD   PAINTED			VINYL			PAINTED	PAINTED	PAINTED	PAINTED			
123 OFFICE SWING SPACE AREA VINYL TILE PTD WOOD PAINTED G.W.B. G.W.B. PAINTED			VINYL	115 11005		G.W.B.	G.W.B.	G.W.B.	G.W.B.			
124 RAMP NO.3 VINYL TILE PTD WOOD — PAINTED PA			VINYL	PTD WOOD		DAINITED			DAINITED			
VINYL STRANGER PAINTED PAINTED PAINTED ACQUISITING			VINYL			PAINTED	PAINTED	PAINTED				
			VINYL	PTD WOOD		PAINTED	PAINTED	PAINTED	PAINTED	ACOUST. TILE		
			TILL			O.W.B.	G.VV.B.	O.W.B.	O.W.B.			

				DC	OOR			FRAME		'ARE	
NO.	TYPE	NOMINA	L DOOR OPENI	NG SIZE	TYPE	MAT'L	FINISH	TYPE	MAT'L	HARDWARE SET#	REMARKS
		W	Н	THK	11175	WATE	FINISH	IIFE	IVIATE	Ť	
101		EXISTING	EXISTING			EXISTING	EXISTING		EXISTING		EXISTING TO REMAIN
102	Α	3'-0"	7'-0"			WOOD	STAINED		METAL		
103	Α	3'-0"	7'-0"			WOOD	STAINED		METAL		
104	Α										
105	Α										
106	Α	<b> </b>	<b>†</b>			♦	<b>†</b>		<b>†</b>		
107	В	3'-0"	7'-0"			WOOD	STAINED		METAL		
108	Α	3'-0"	7'-0"			WOOD	STAINED		METAL		
109	Α	3'-0"	7'-0"			WOOD	STAINED		METAL		
110	D	3'-0"	7'-0"			WOOD	STAINED		METAL		
111		EXISTING	EXISTING			EXISTING	EXISTING				EXISTING TO REMAIN
112		EXISTING	EXISTING			EXISTING	EXISTING				EXISTING TO REMAIN
113		EXISTING	EXISTING			EXISTING	EXISTING				EXISTING TO REMAIN
114	Α	3'-0"	7'-0"			WOOD	STAINED		METAL		
115	F					WOOD	STAINED		METAL		
116	Α		•			WOOD	STAINED		METAL		
117	Е	3'-0"	7'-0"			WOOD	STAINED		METAL		
118	D	3'-0"	7'-0"			WOOD	STAINED		METAL		
119	G	3'-0"	7'-0"			WOOD	STAINED		METAL		FIRE RATED 2 HOURS

	WINDOW SCHEDULE										
				WINI	DOW	FRAME					
NO.	TYPE	WINDO	W OPENING SI	ZE	TYPE MAT'L FINISH	AAA TU		TVDE		REMARKS	
		W	Н	THK		FINISH	TYPE MAT'L	MAT'L			
101	В	6'-0"	4'-8"			METAL	STAINED			HURRICANE RESISTANT AND BULLET RESISTANT GLASS,W/TINT	
102	А	2'-0"	4'-8"			METAL	STAINED			BOLLET REGIOTATE GEAGG, WATHER	
103	В	6'-0"	4'-8"			METAL	STAINED				
104	В	6'-0"	4'-8"			METAL					
105	D	4'-0"	4'-8"			METAL					
106	D	4'-0"	4'-8"			METAL					
107	D	4'-0"	4'-8"			METAL					
108	D	4'-0"	4'-8"			METAL					
109	D	4'-0"	4'-8"			METAL				•	
110	С	3'-0"	4'-8"			METAL				HURRICANE RÉSISTANT AND BULLET RESISTANT GLASS,W/TINT	



Kronprindsens Quarter St. Thomas, U.S.V.I. 00802

ISSUE FOR BID

INTERIOR, WINDOW AND DOOR SCHEDULES & DOOR ELEVATIONS

REVISIONS

DRAWN BY: O.C. & B.S.

CHECKED BY: D. deJongh


DATE: 05/01/2018

JOB NO: 2017.1

A2.01

1	INTERIOR FINISH SCHEDULE
	HINTERIOR FINION OCHEDULE


NOT TO SCALE

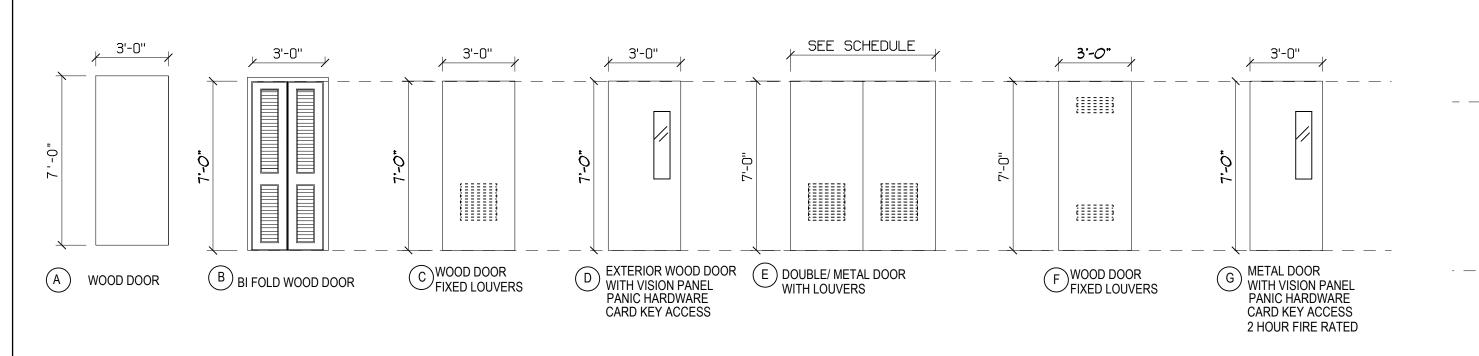



HURRICANE RESISTANT GLASS WITH TINT  CONC. WINDOW SILL		6'-0"	-4 0,,		— — — — — — — — — — — — — — — — — — —
	$\langle A \rangle$	B	C	$\langle D \rangle$	
	EXTERIOR WINDOW	EXTERIOR WINDOW	EXTERIOR WINDOW	EXTERIOR WINDOW	

2 DOOR ELEVATIONS

NOT TO SCALE

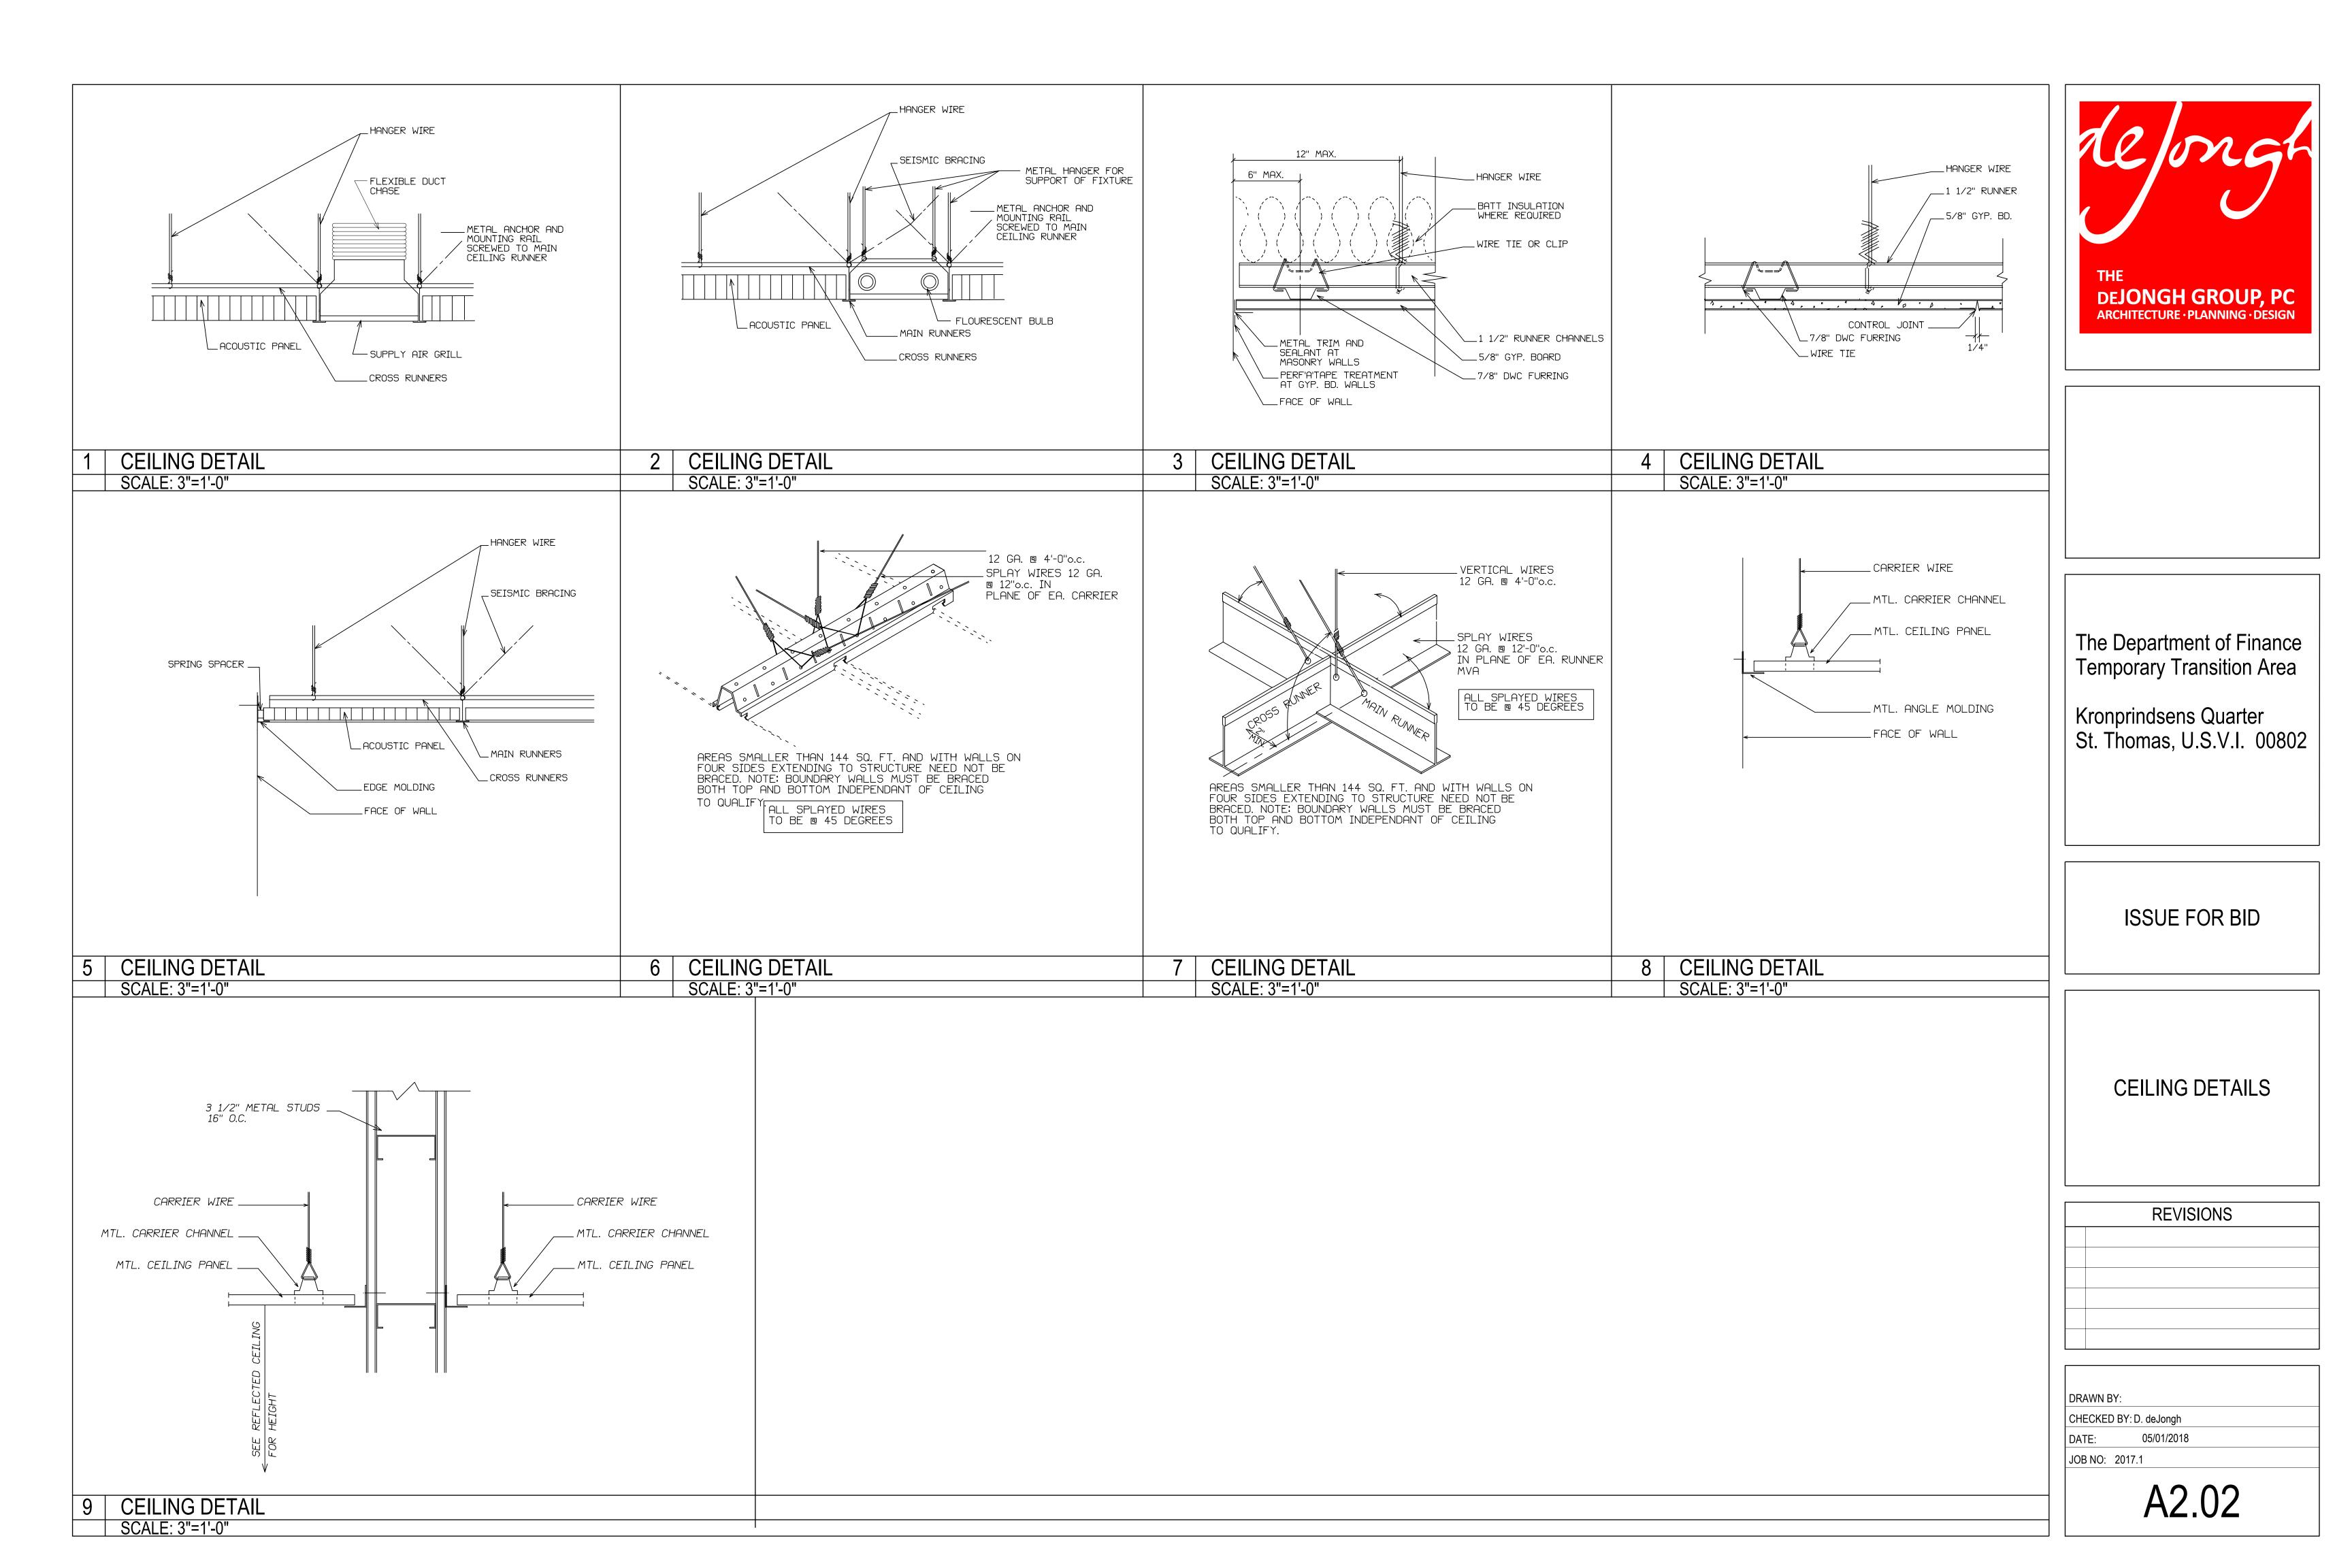

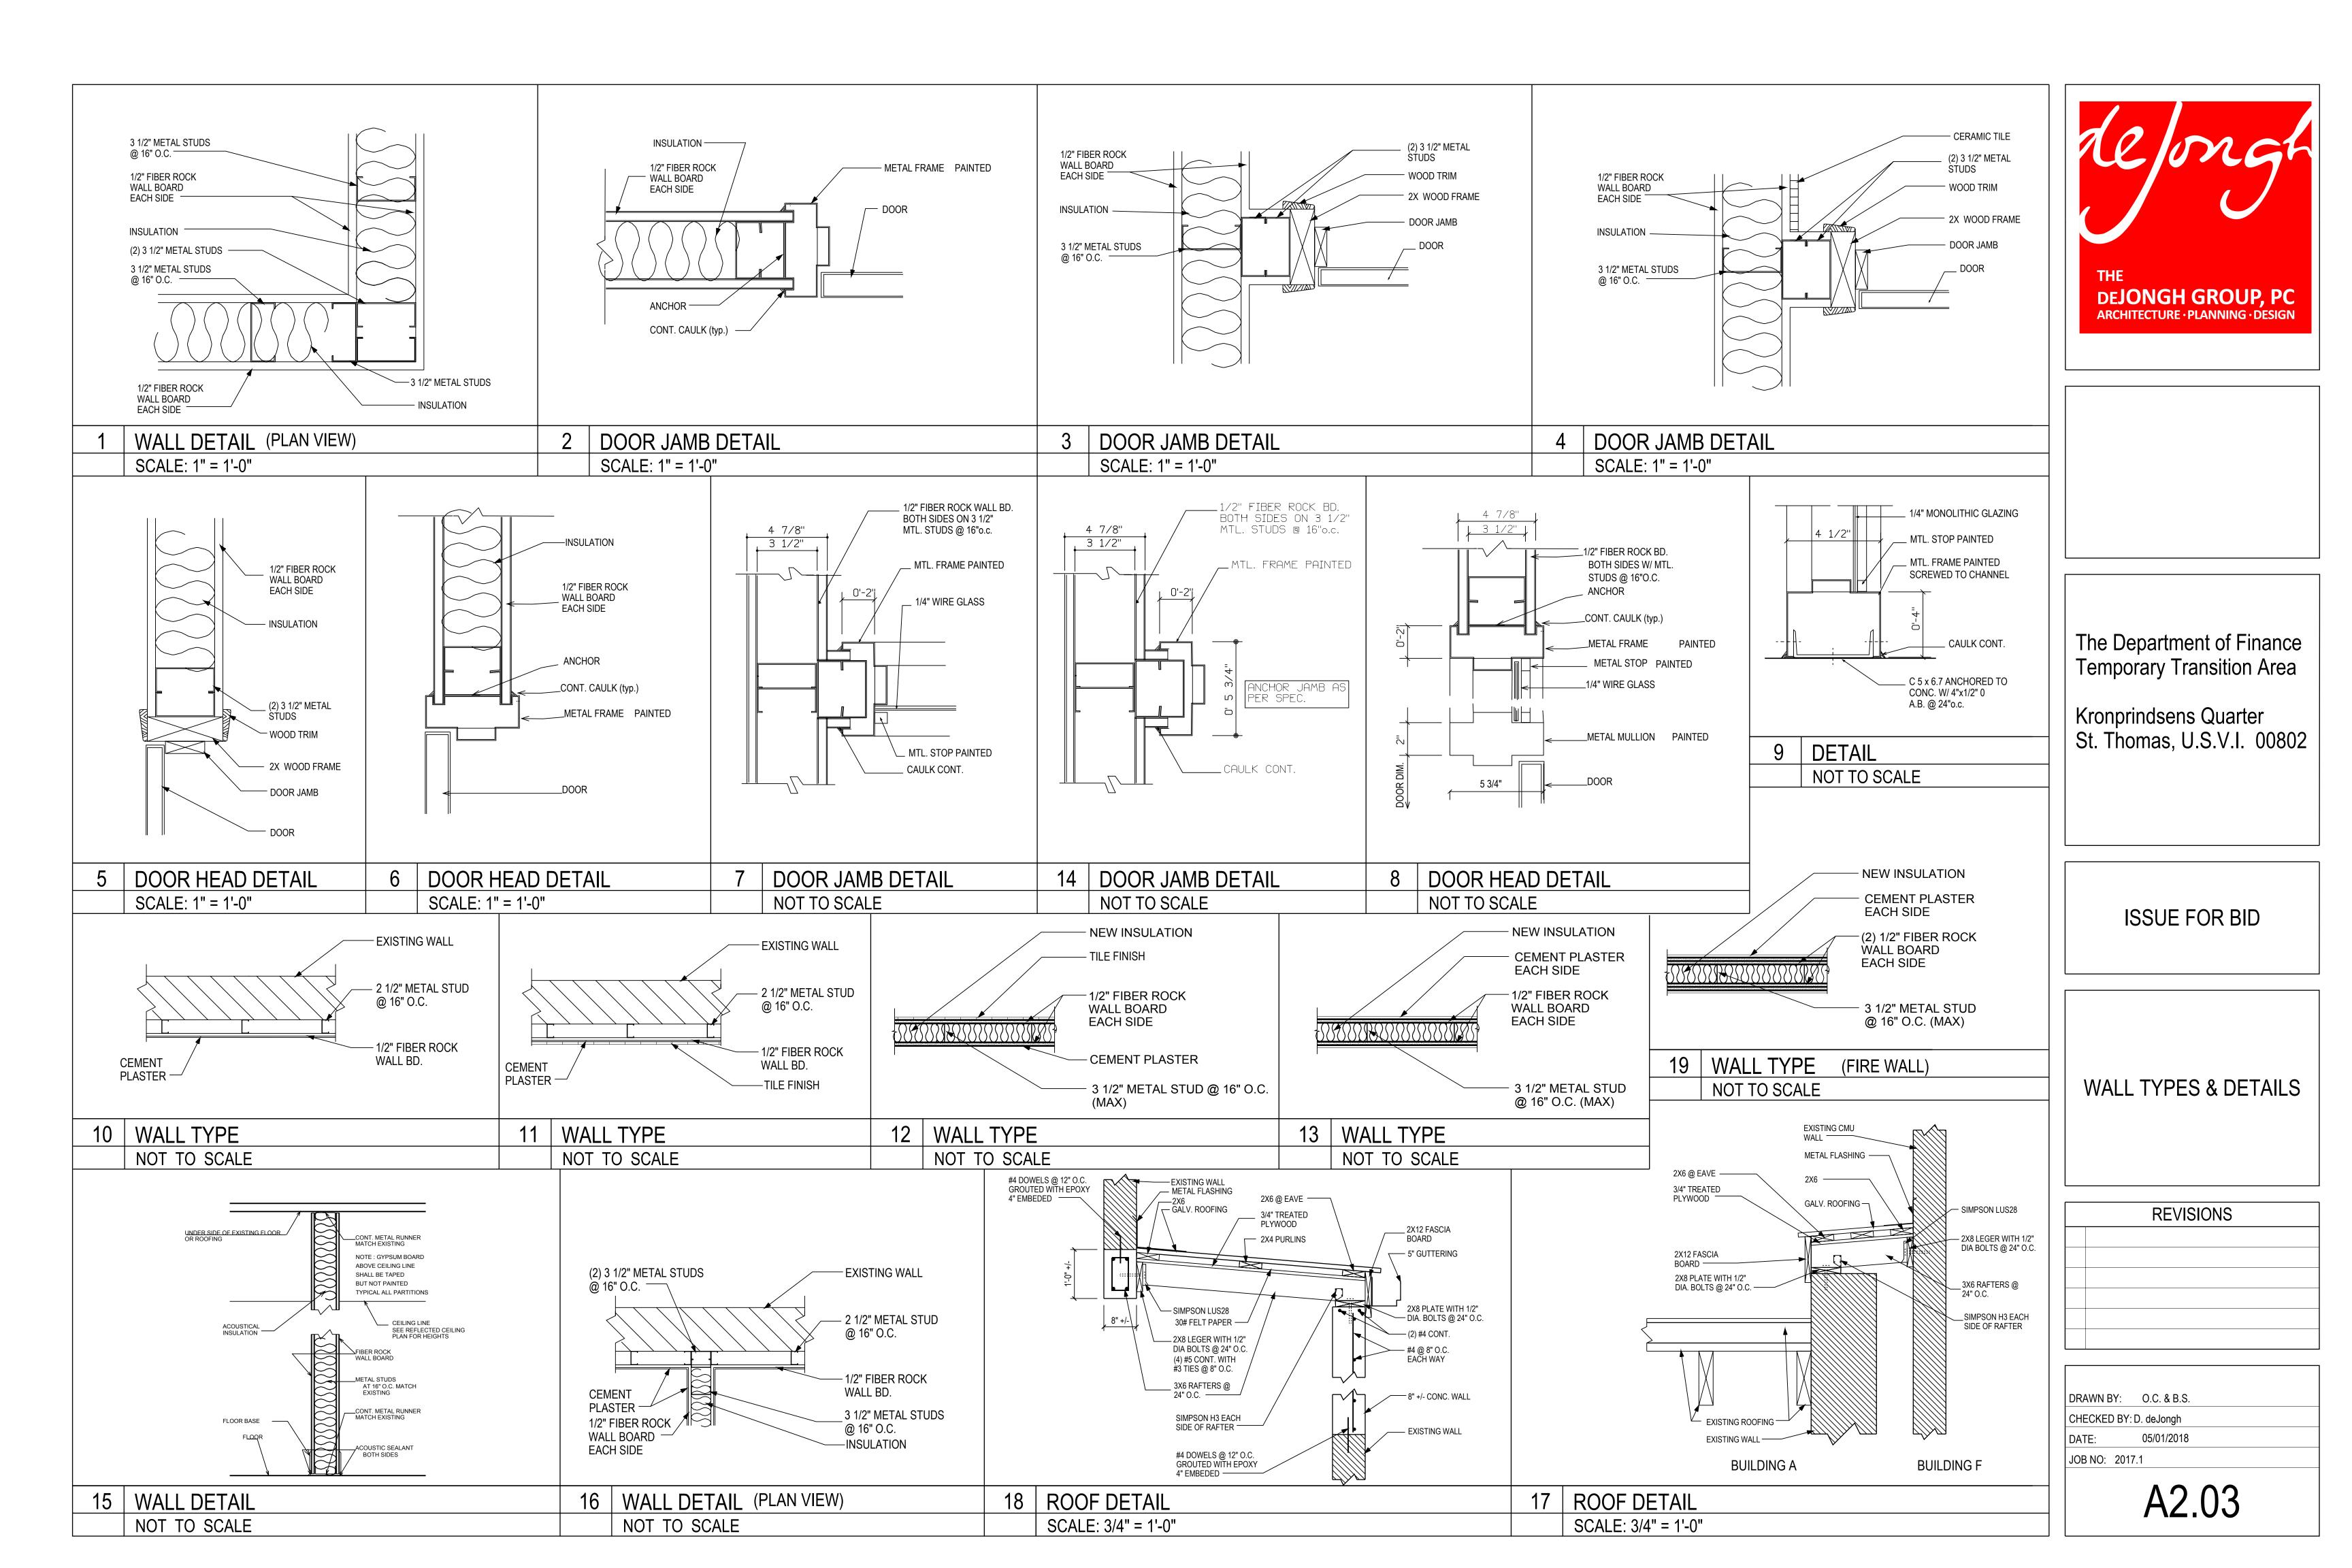

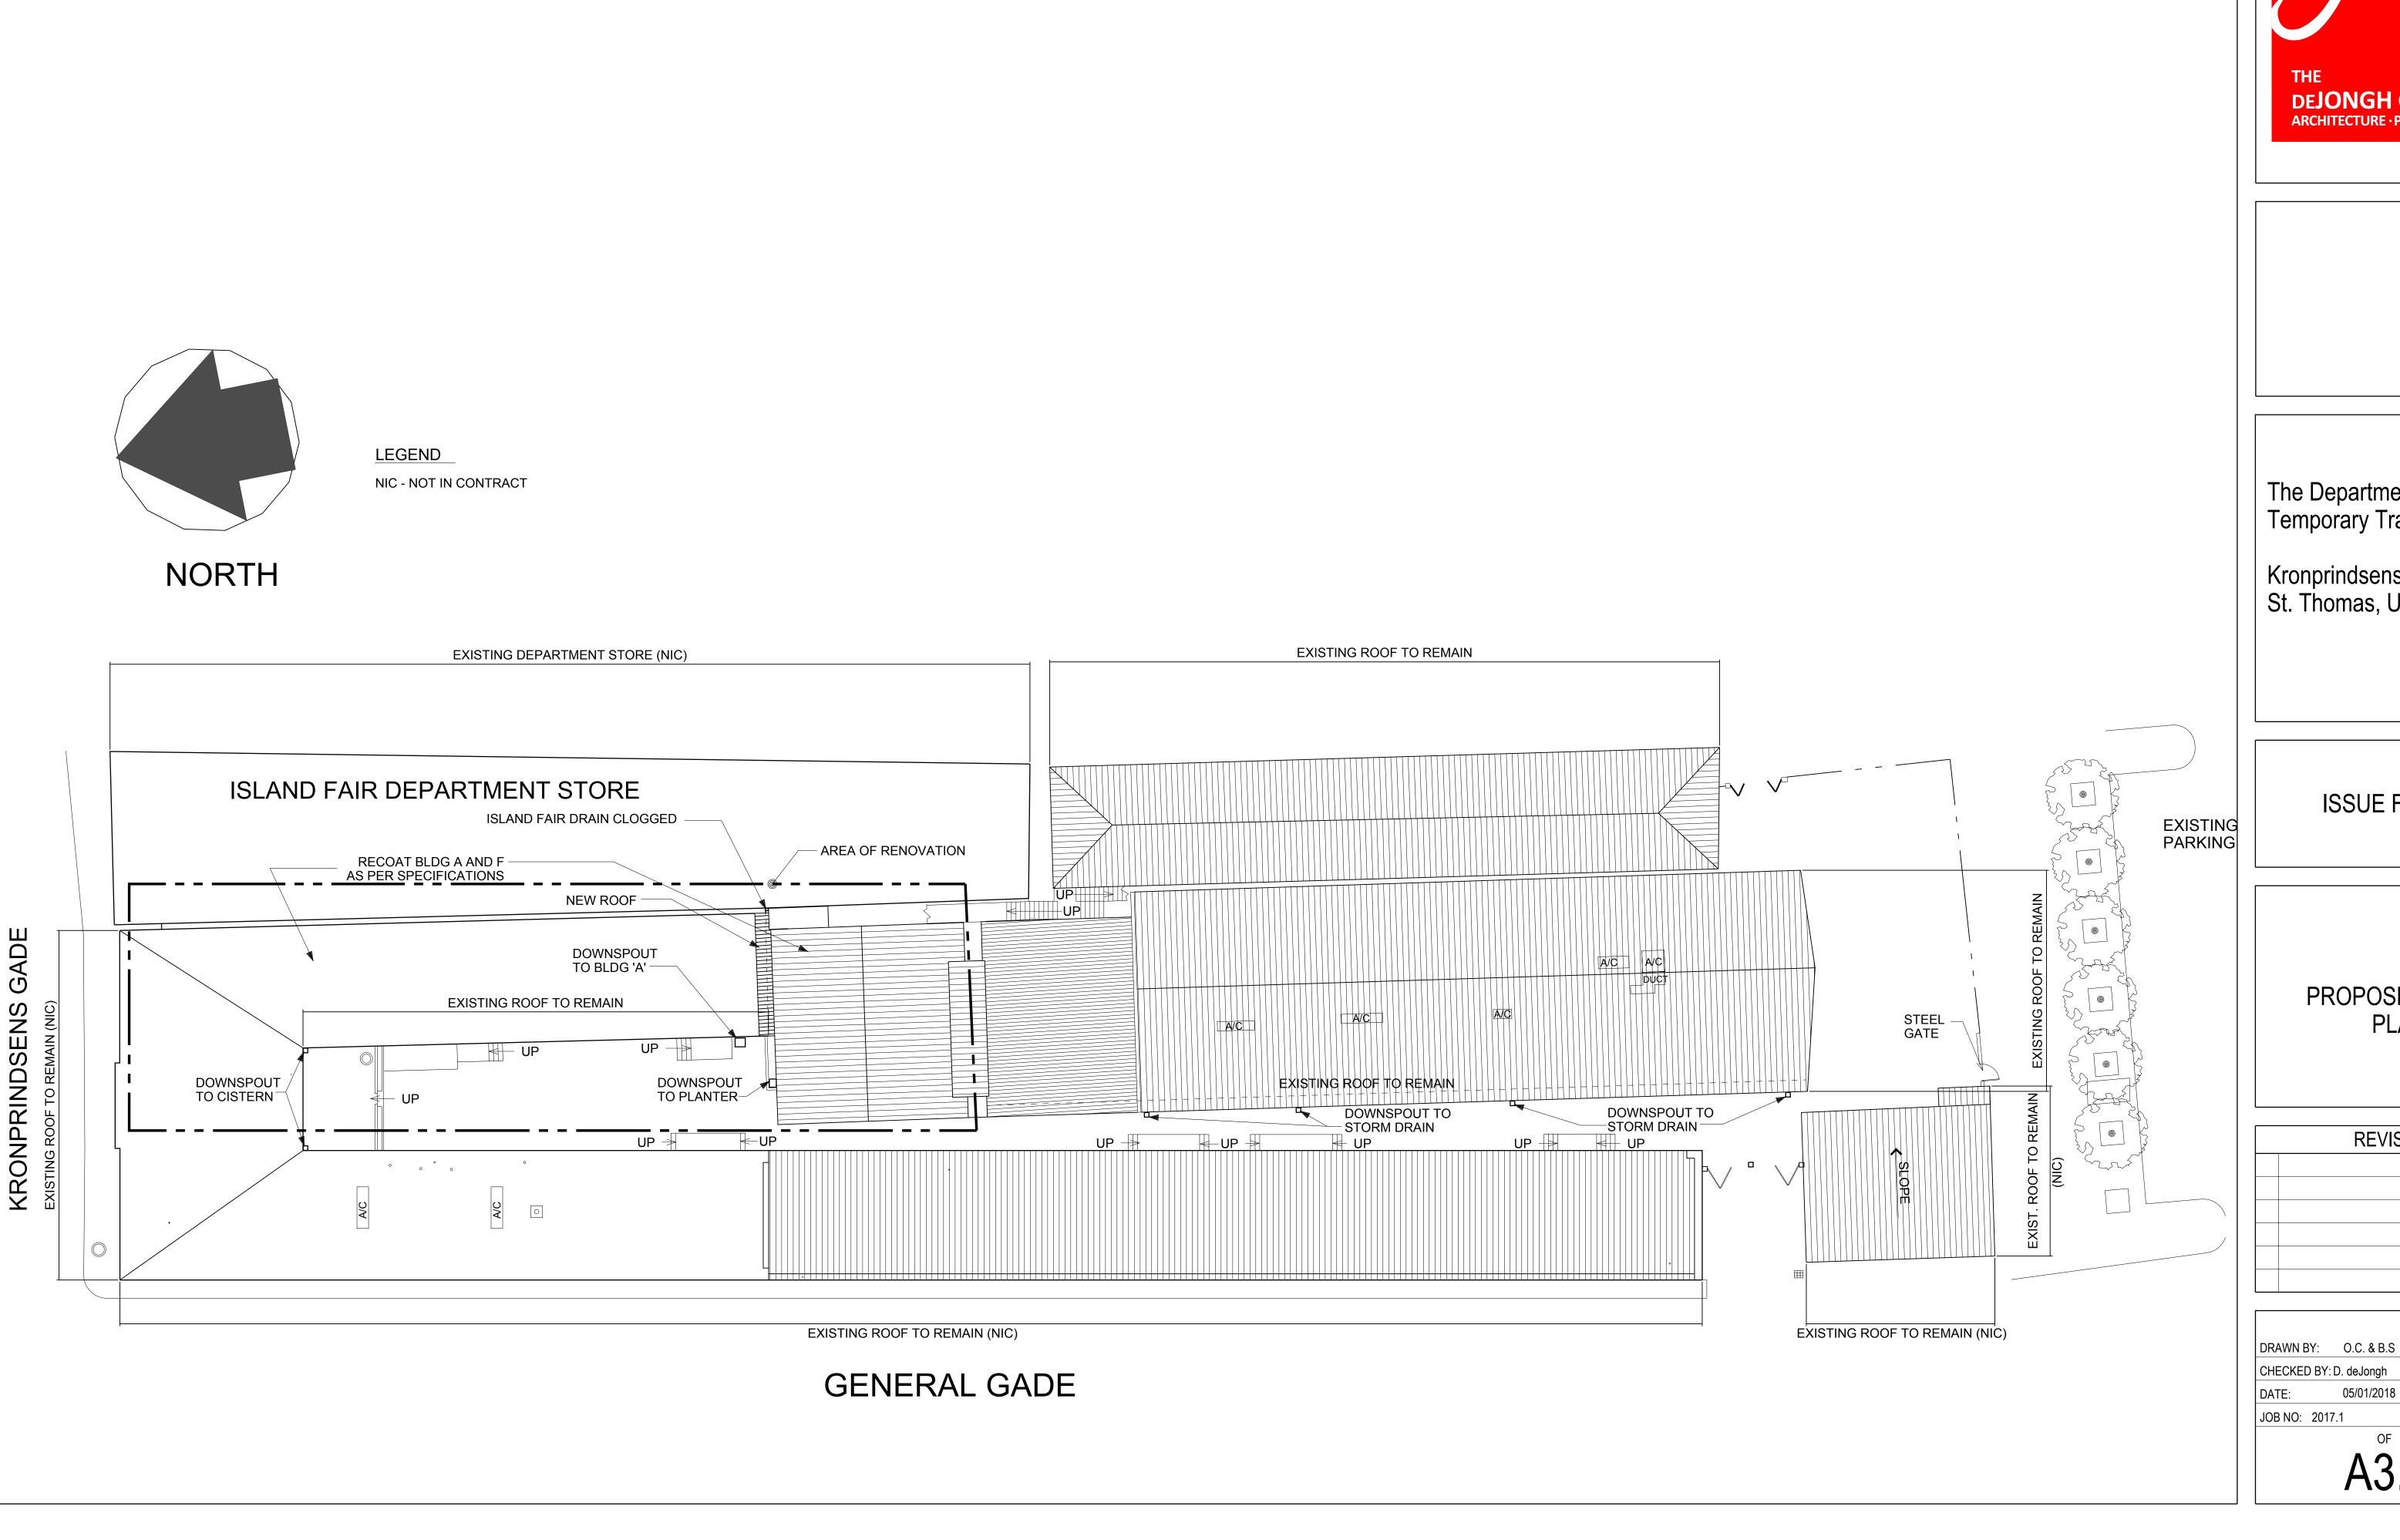




Kronprindsens Quarter St. Thomas, U.S.V.I. 00802


ISSUE FOR BID


PROPOSED ROOF PLAN


**REVISIONS** 


DRAWN BY: O.C. & B.S

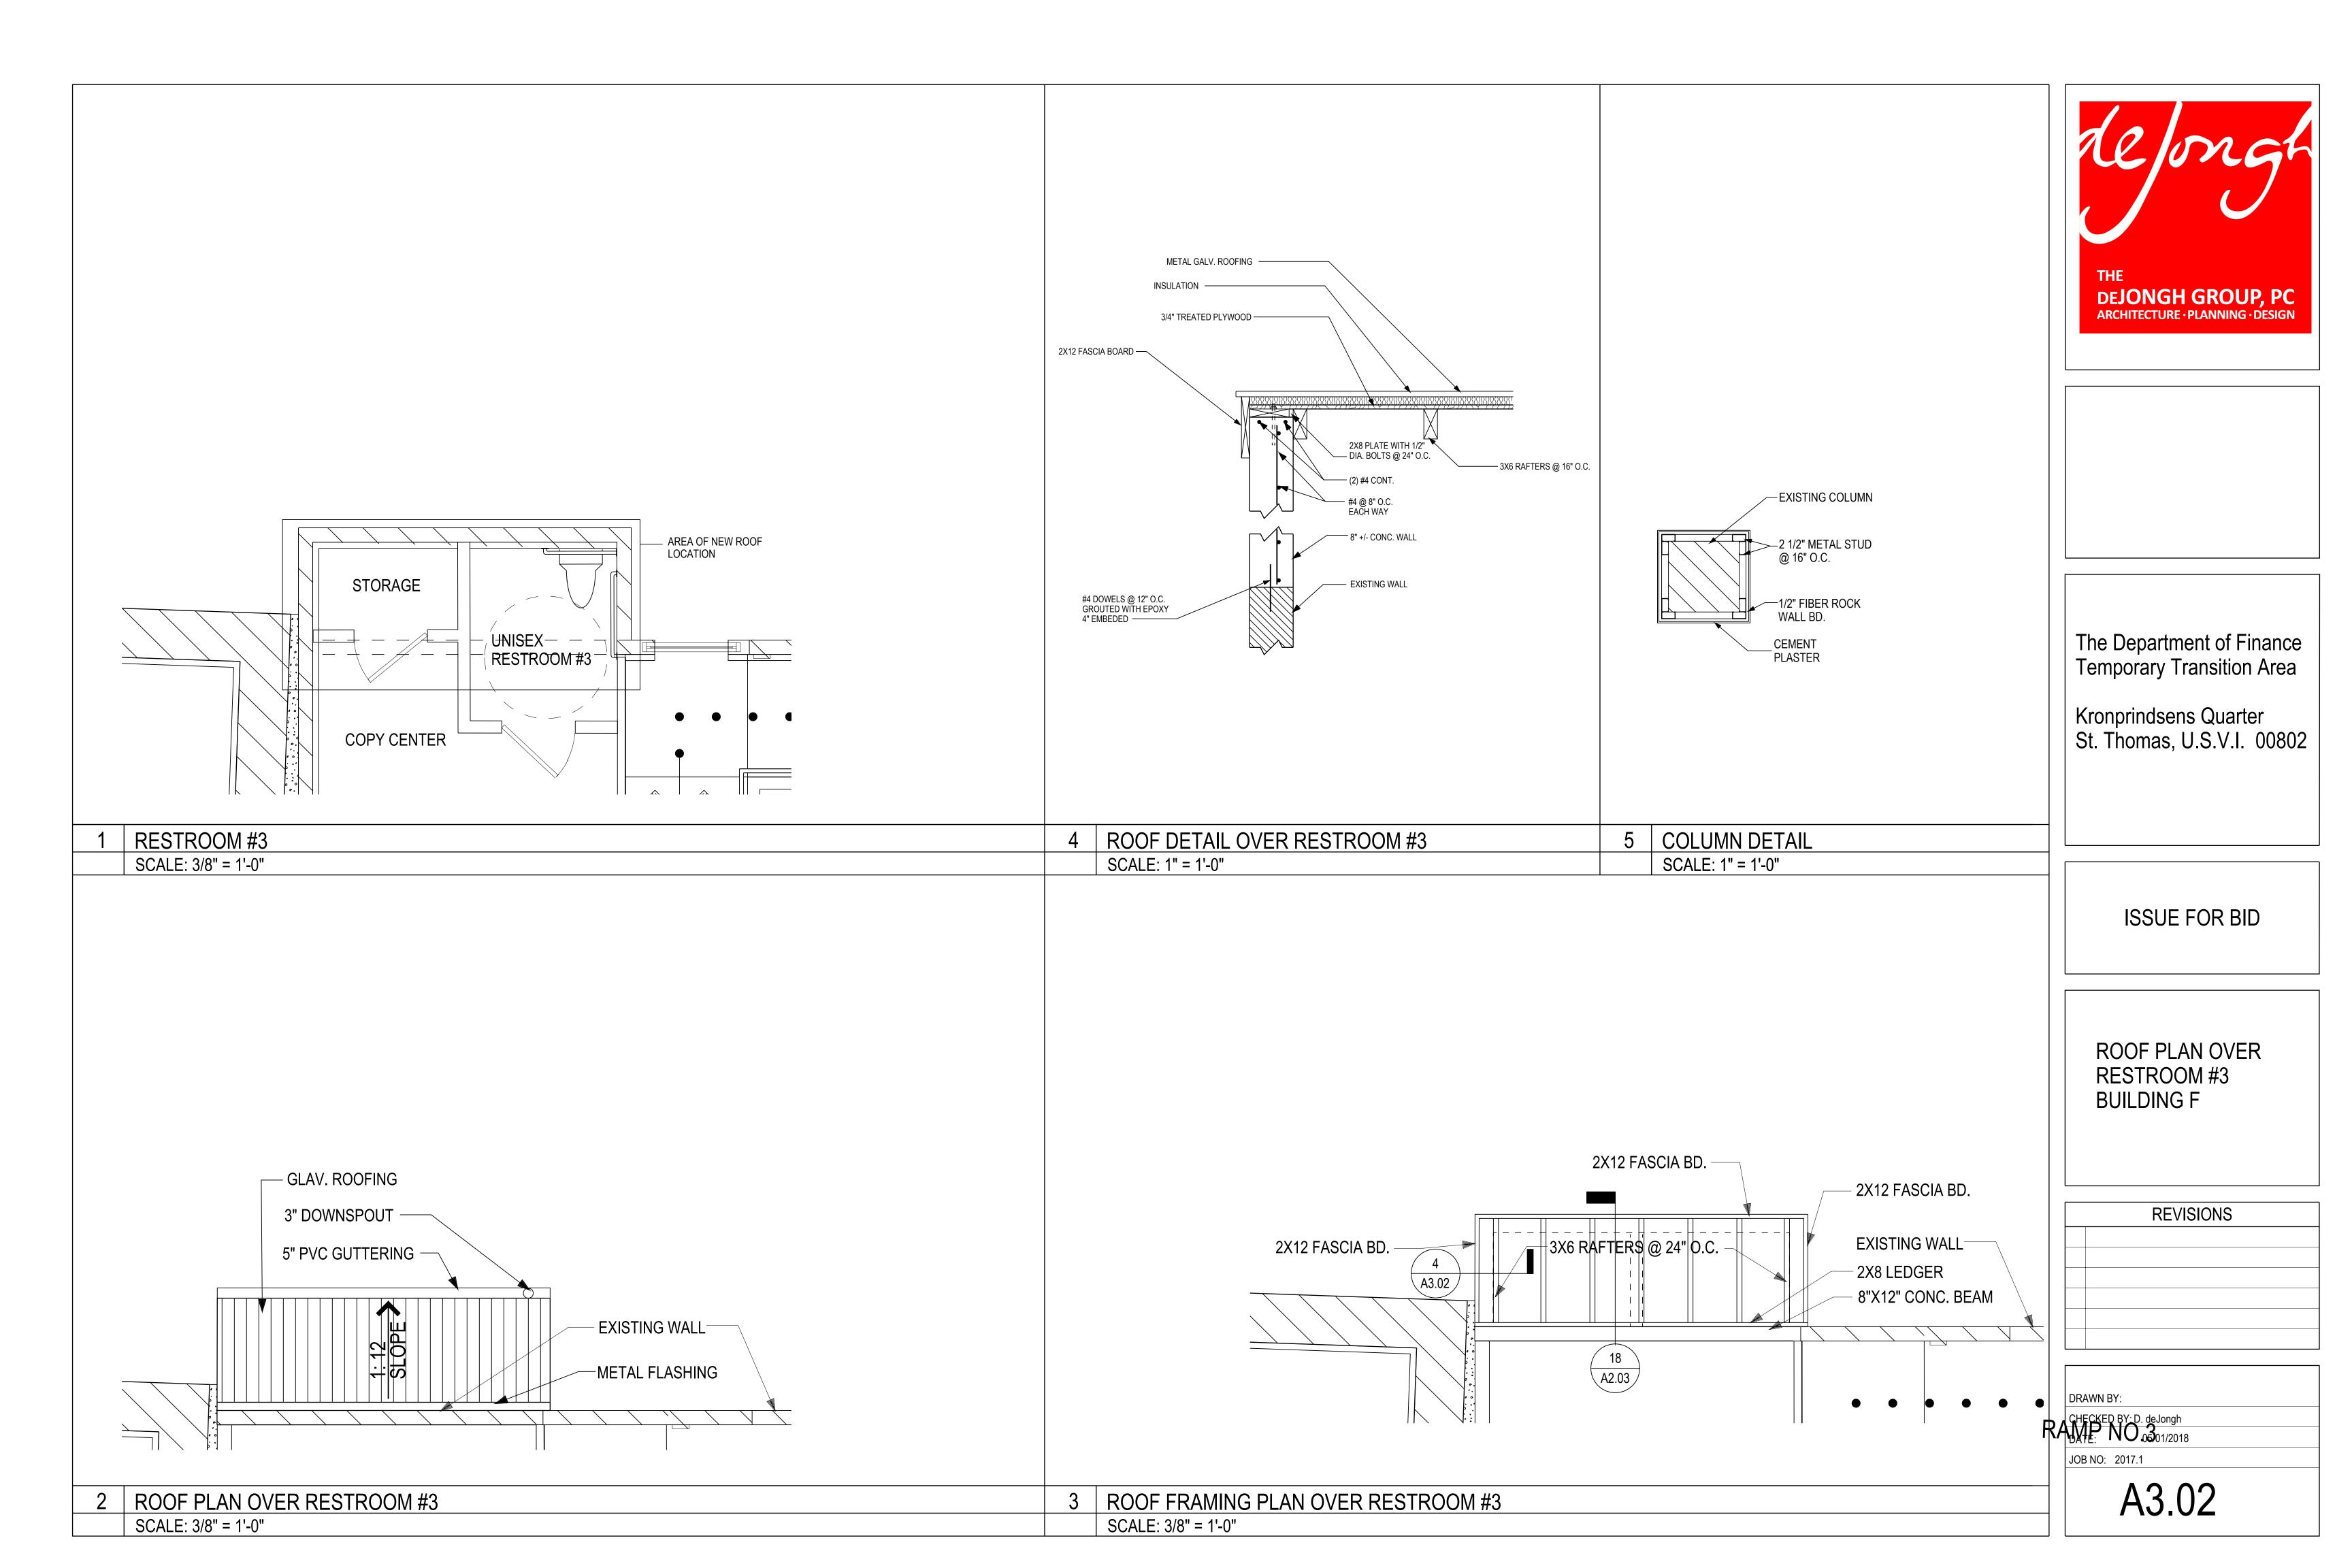


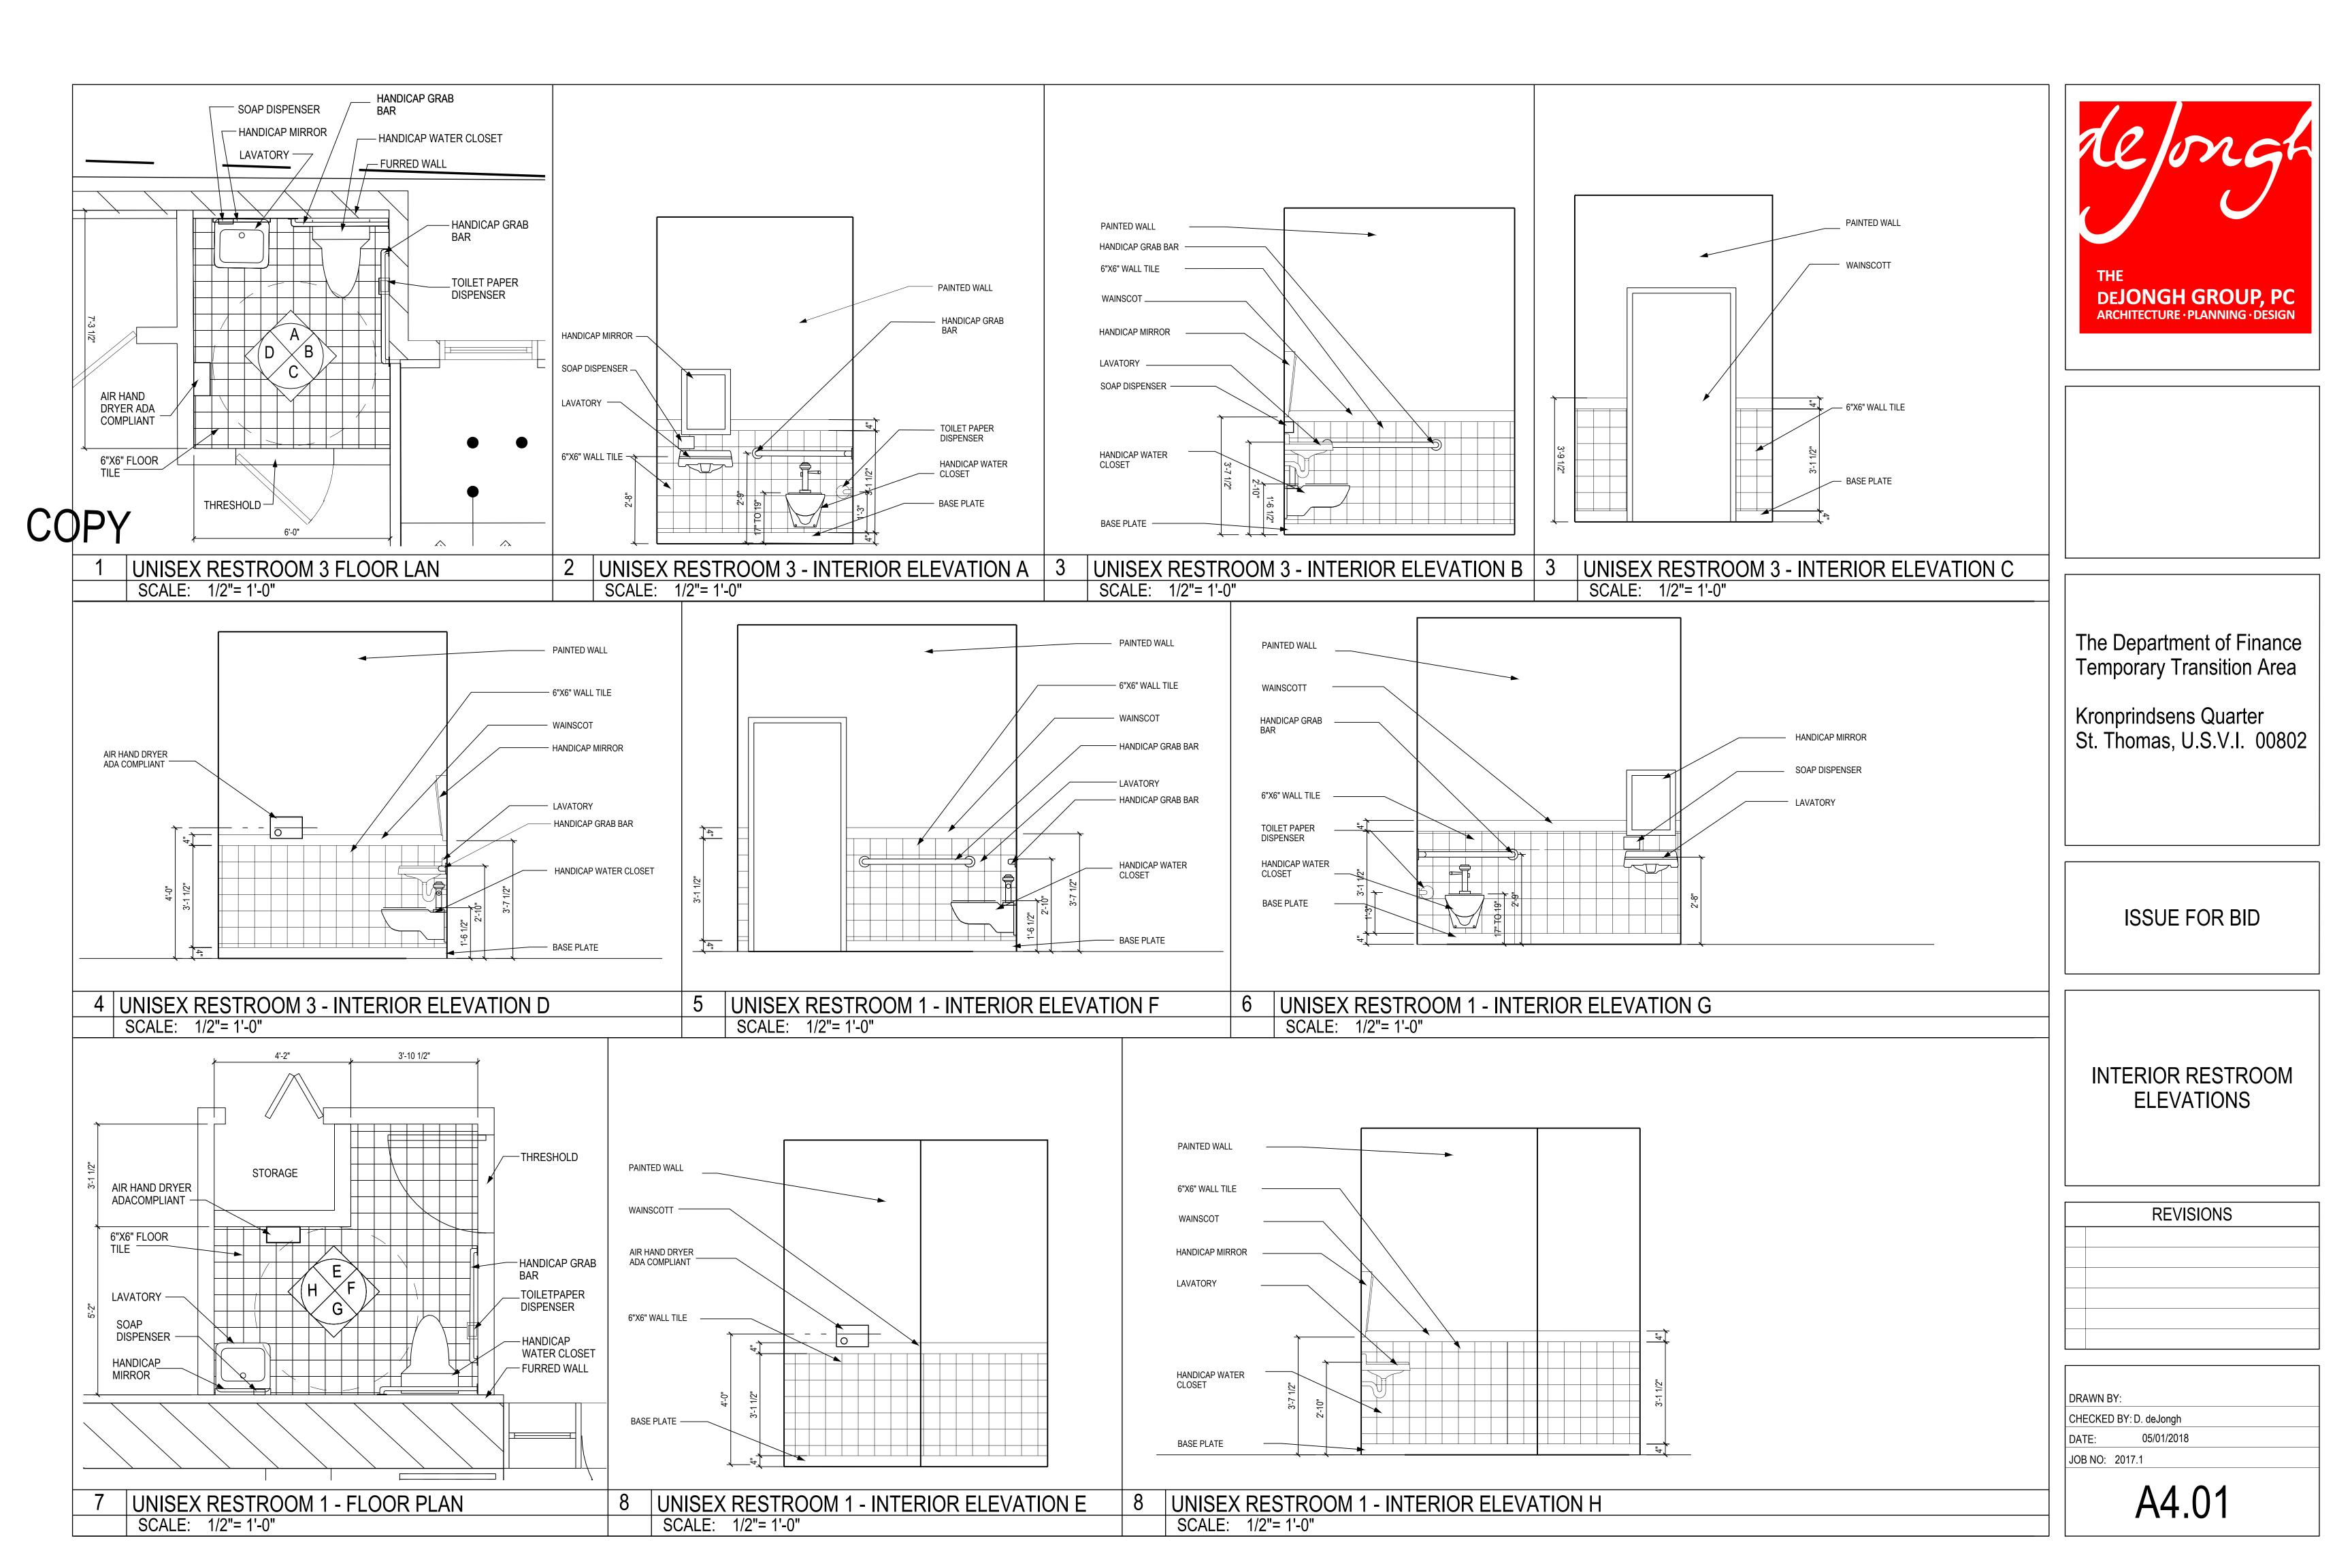


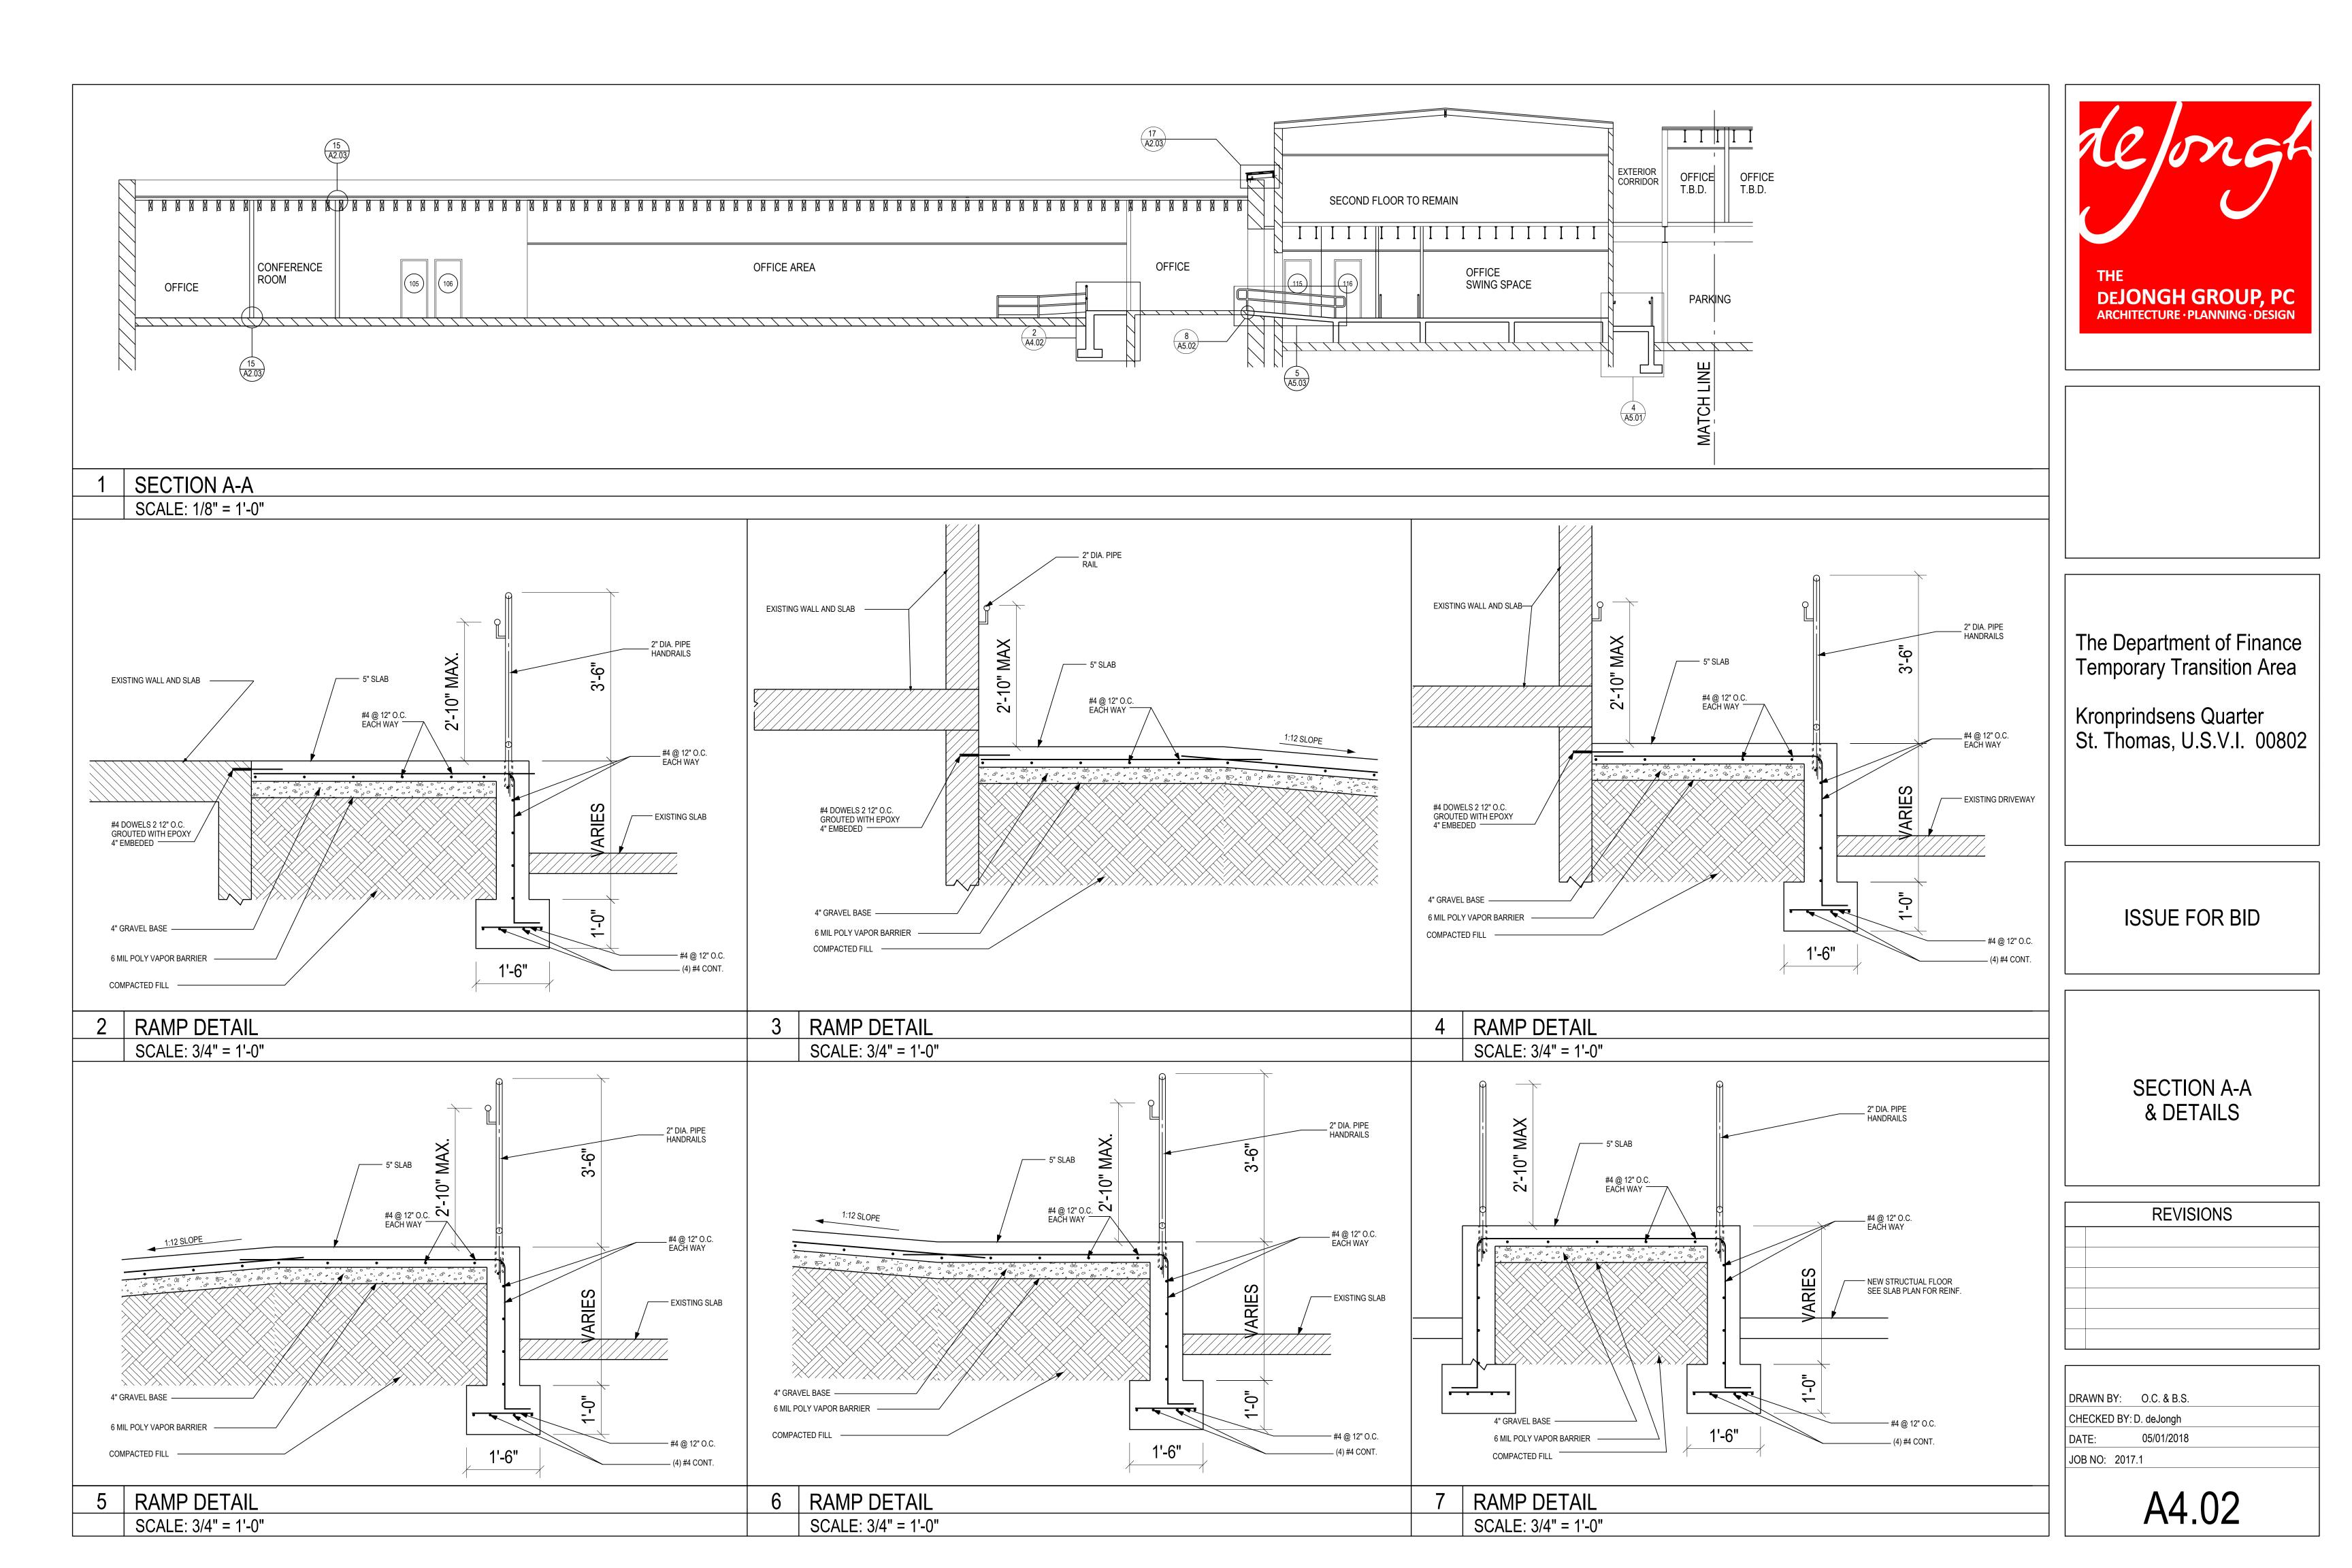


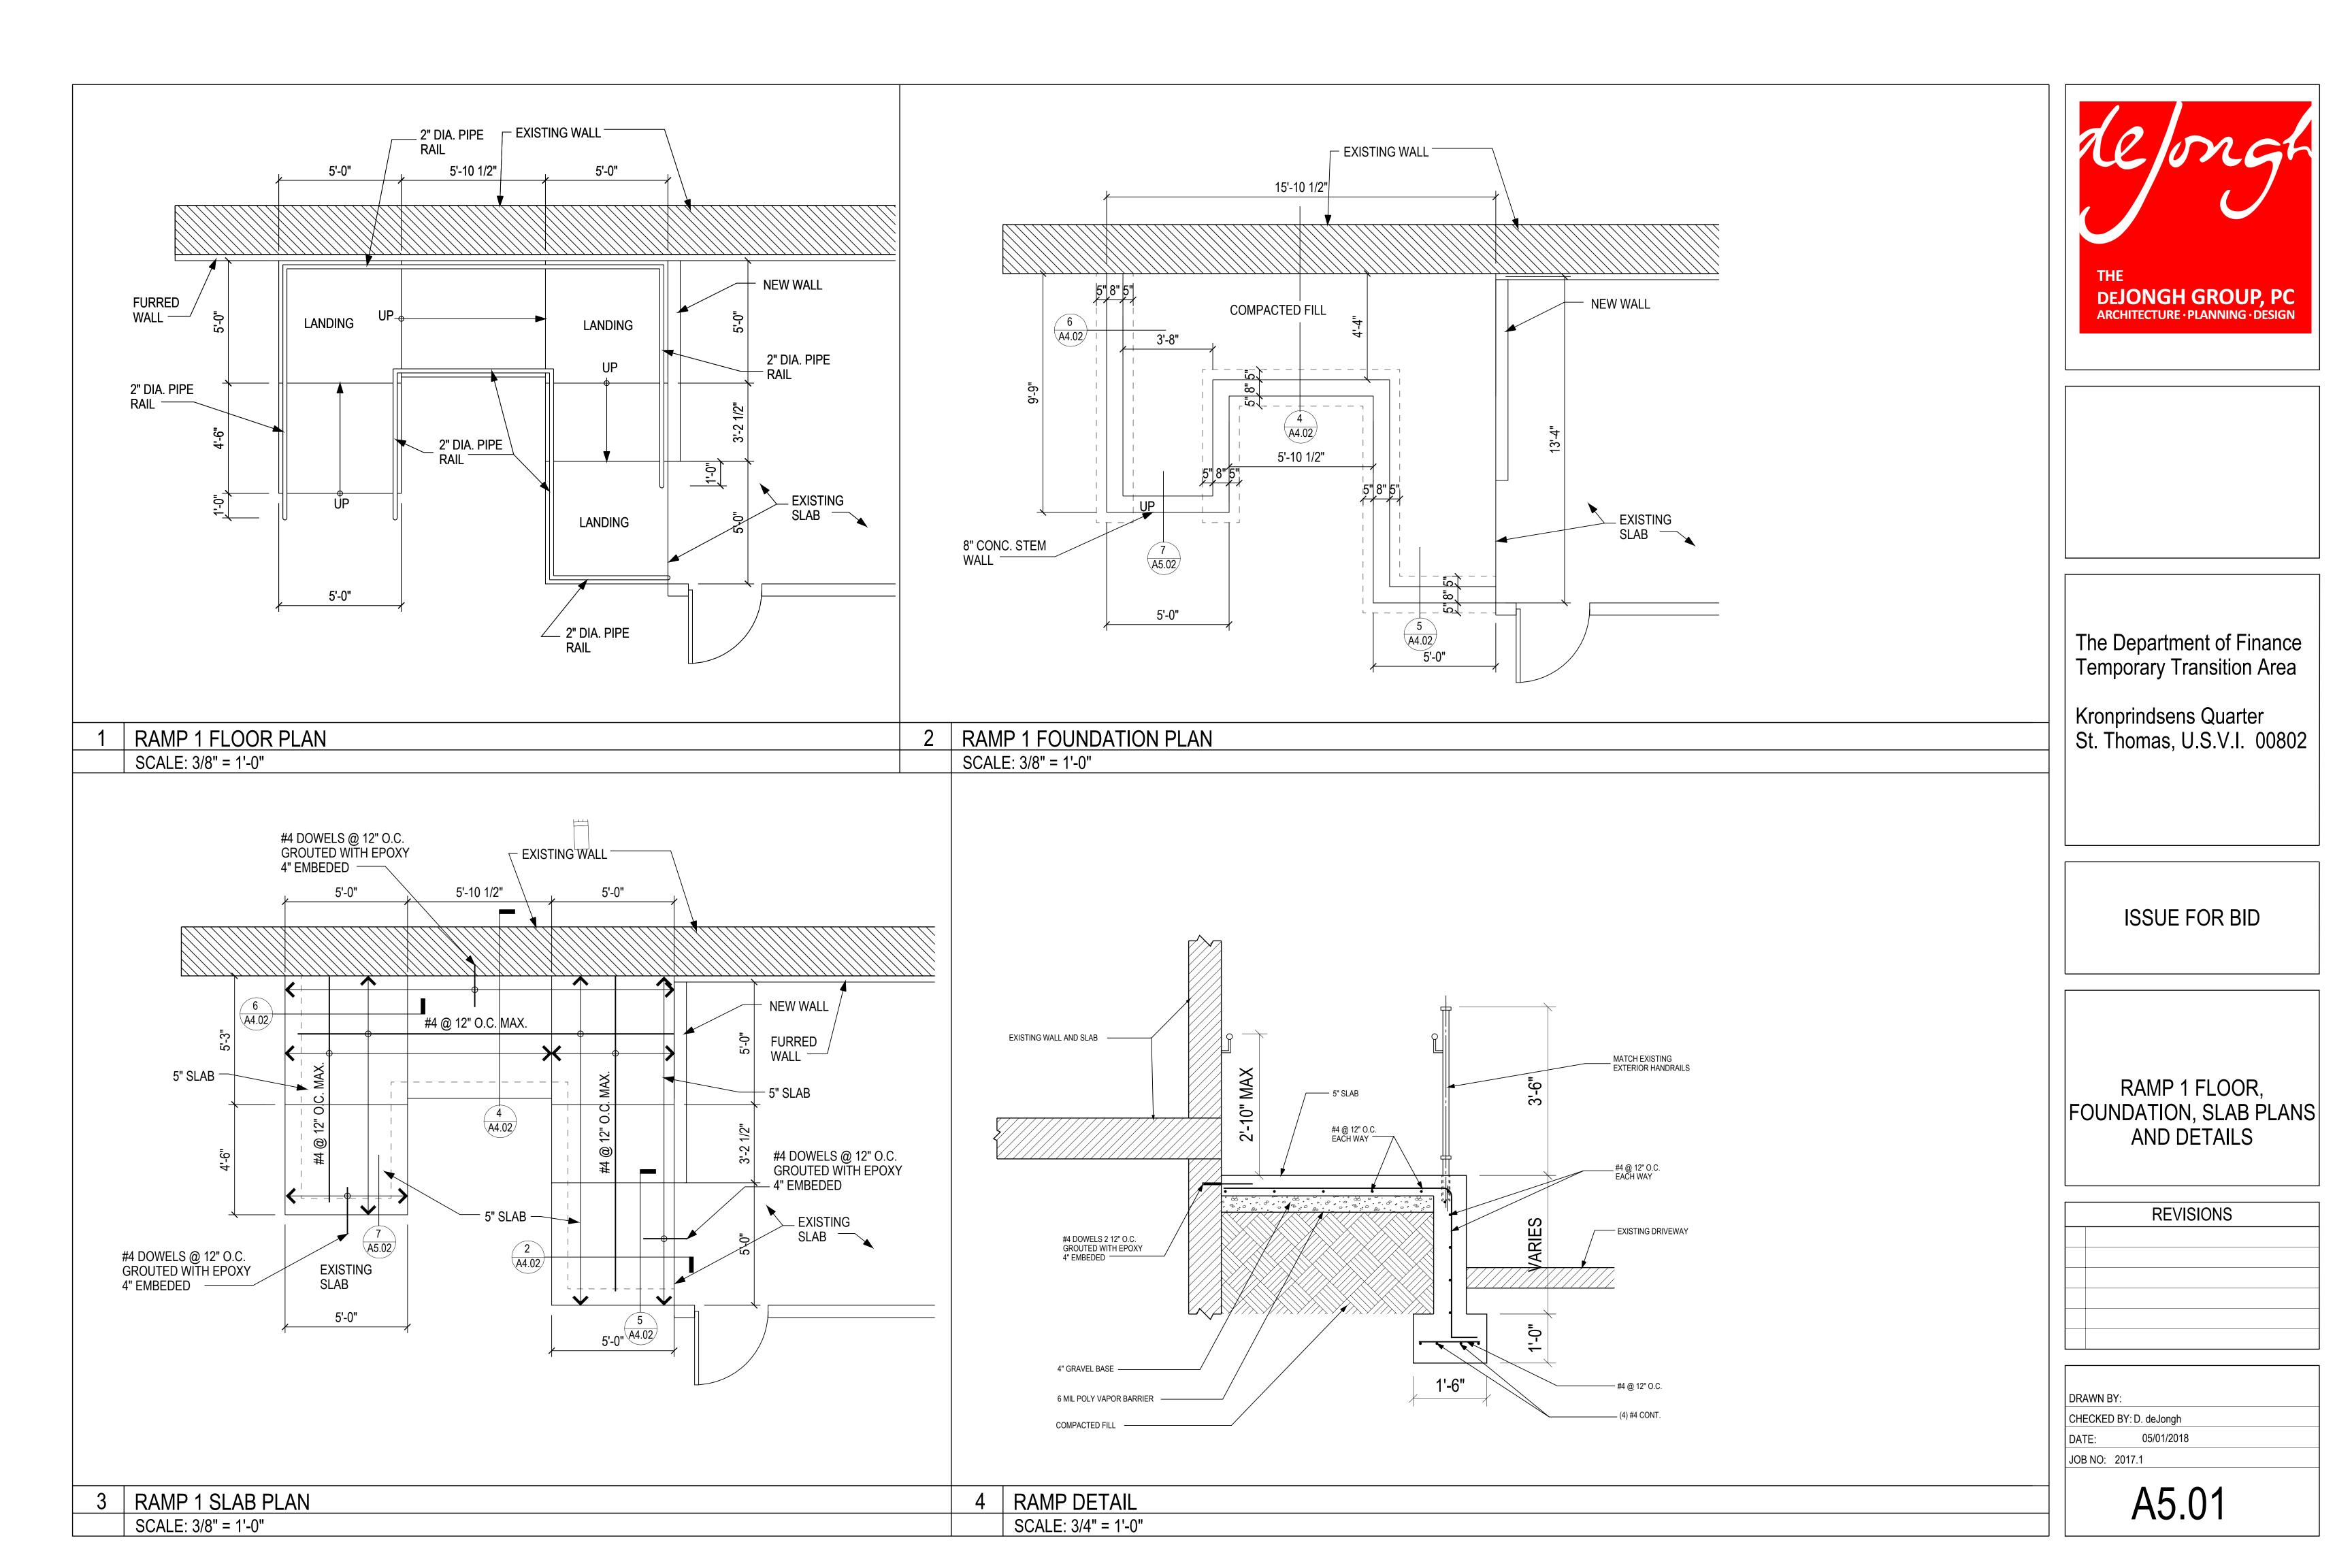


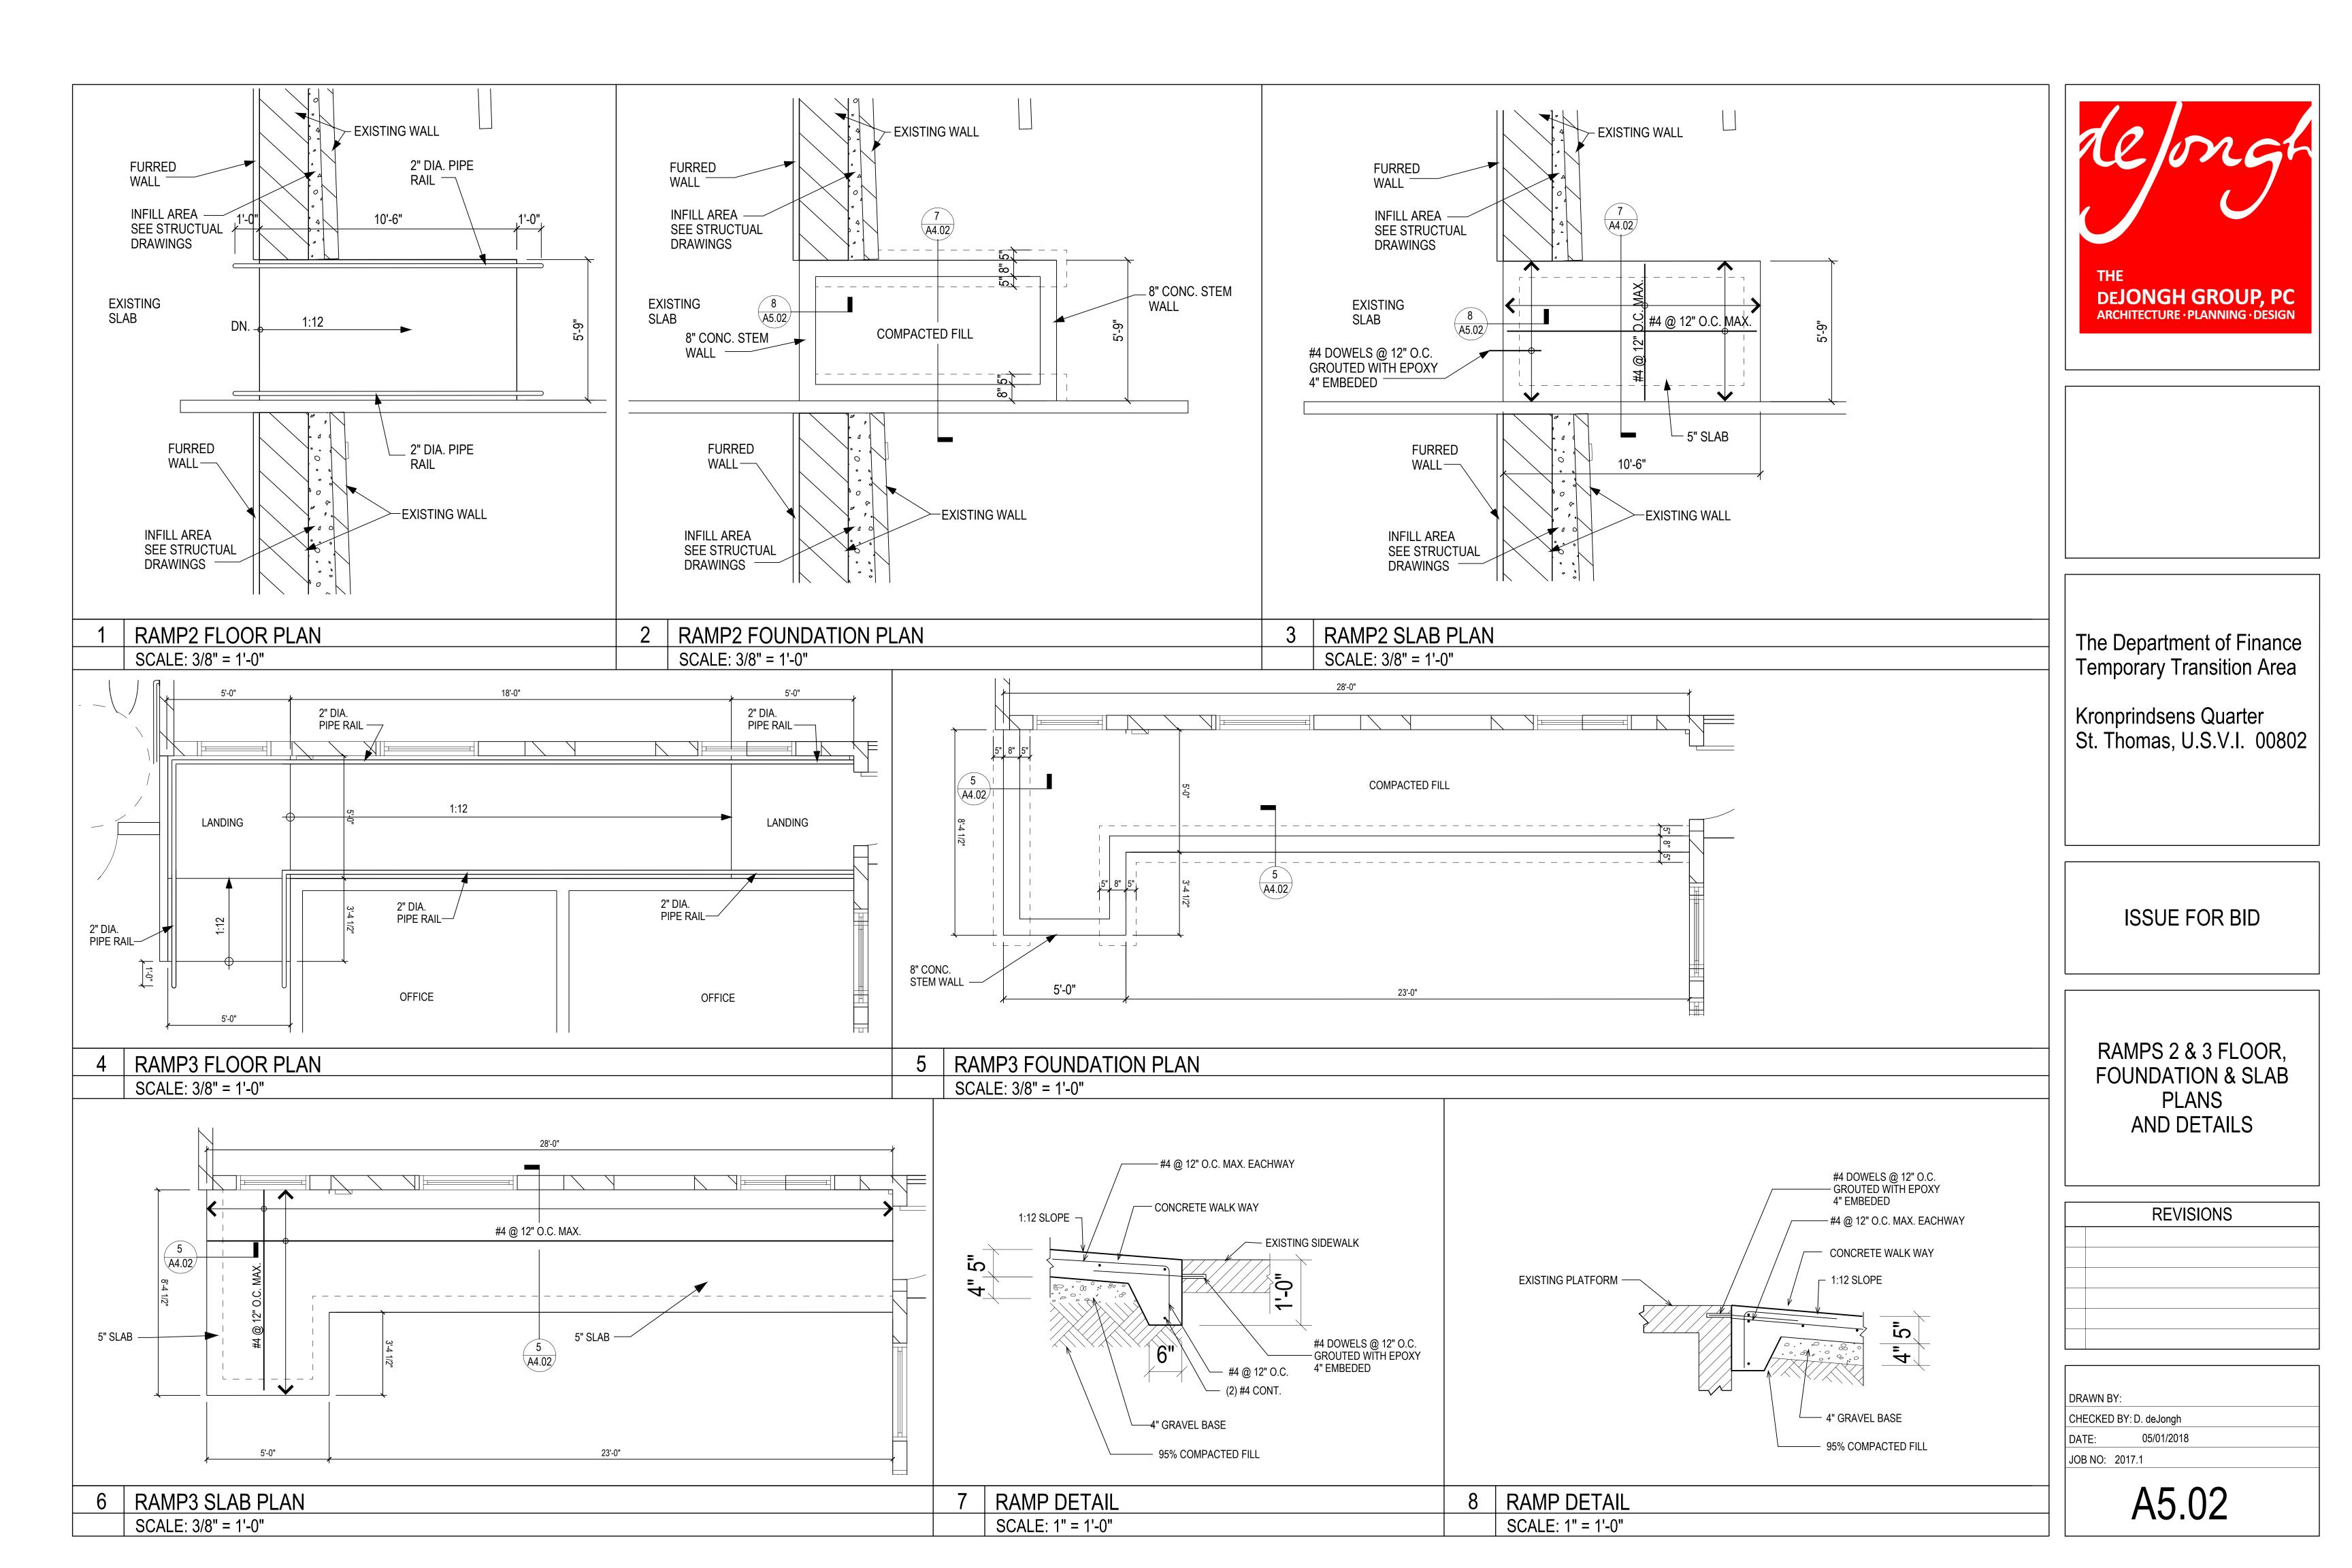


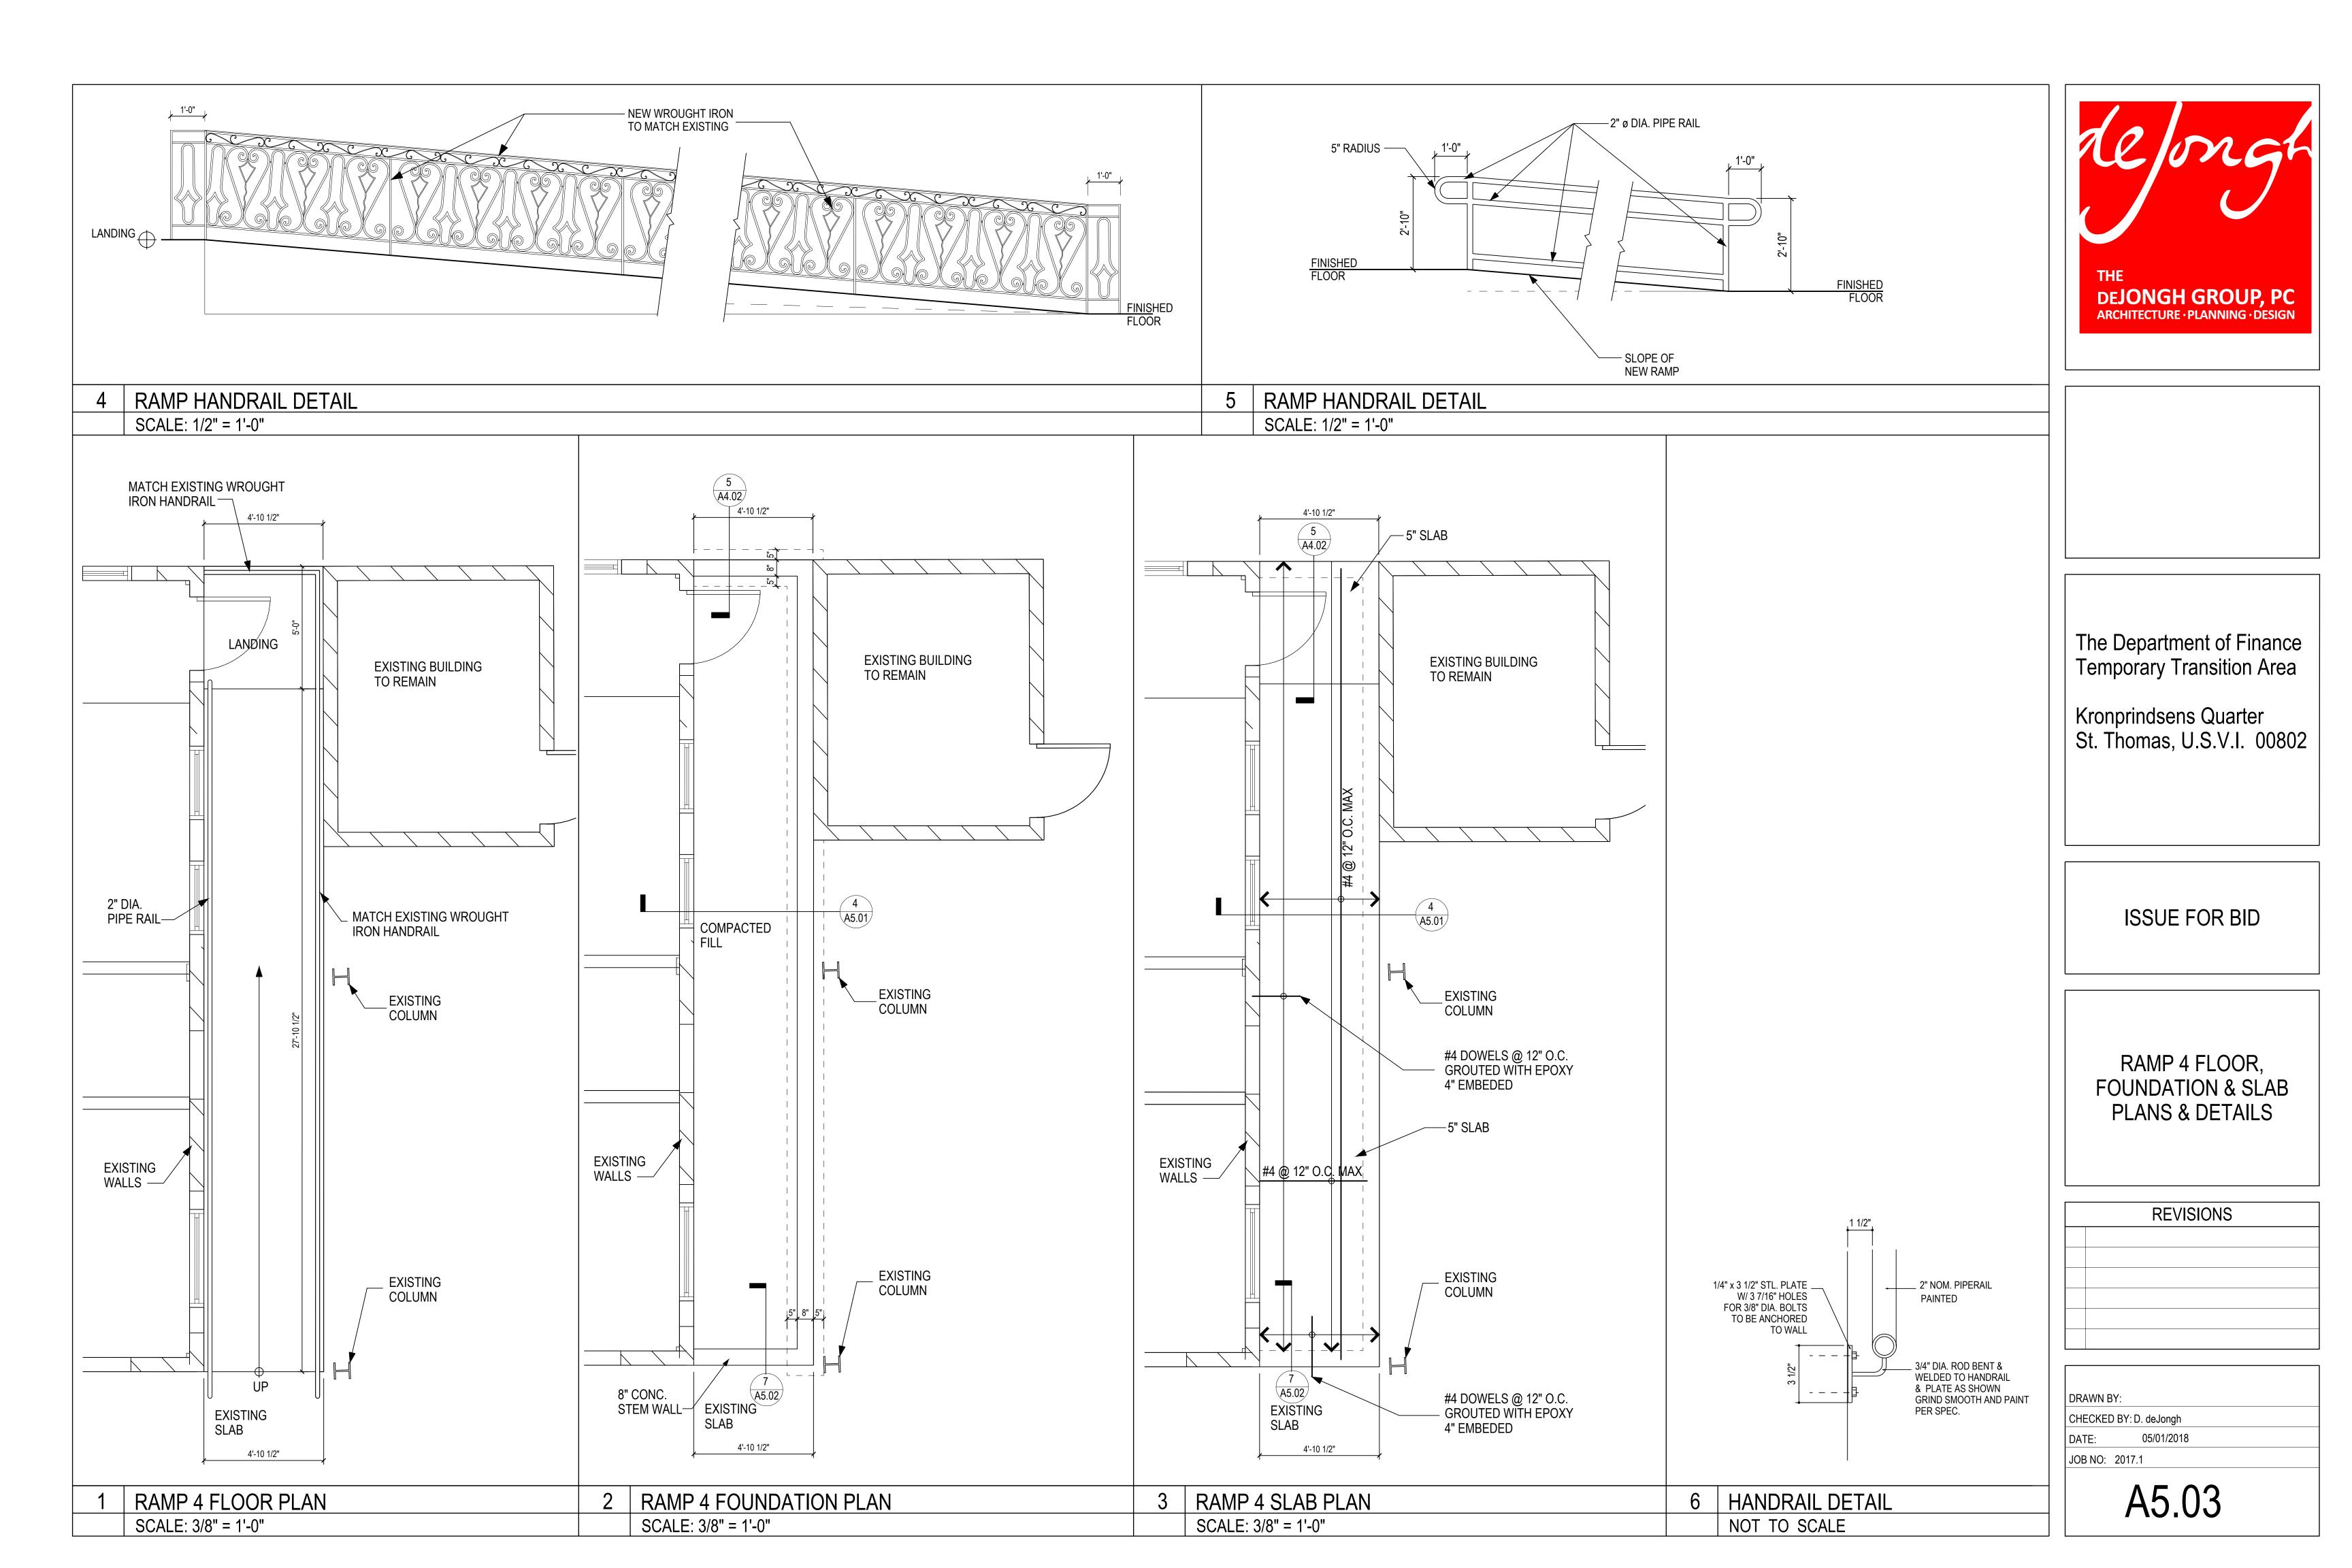


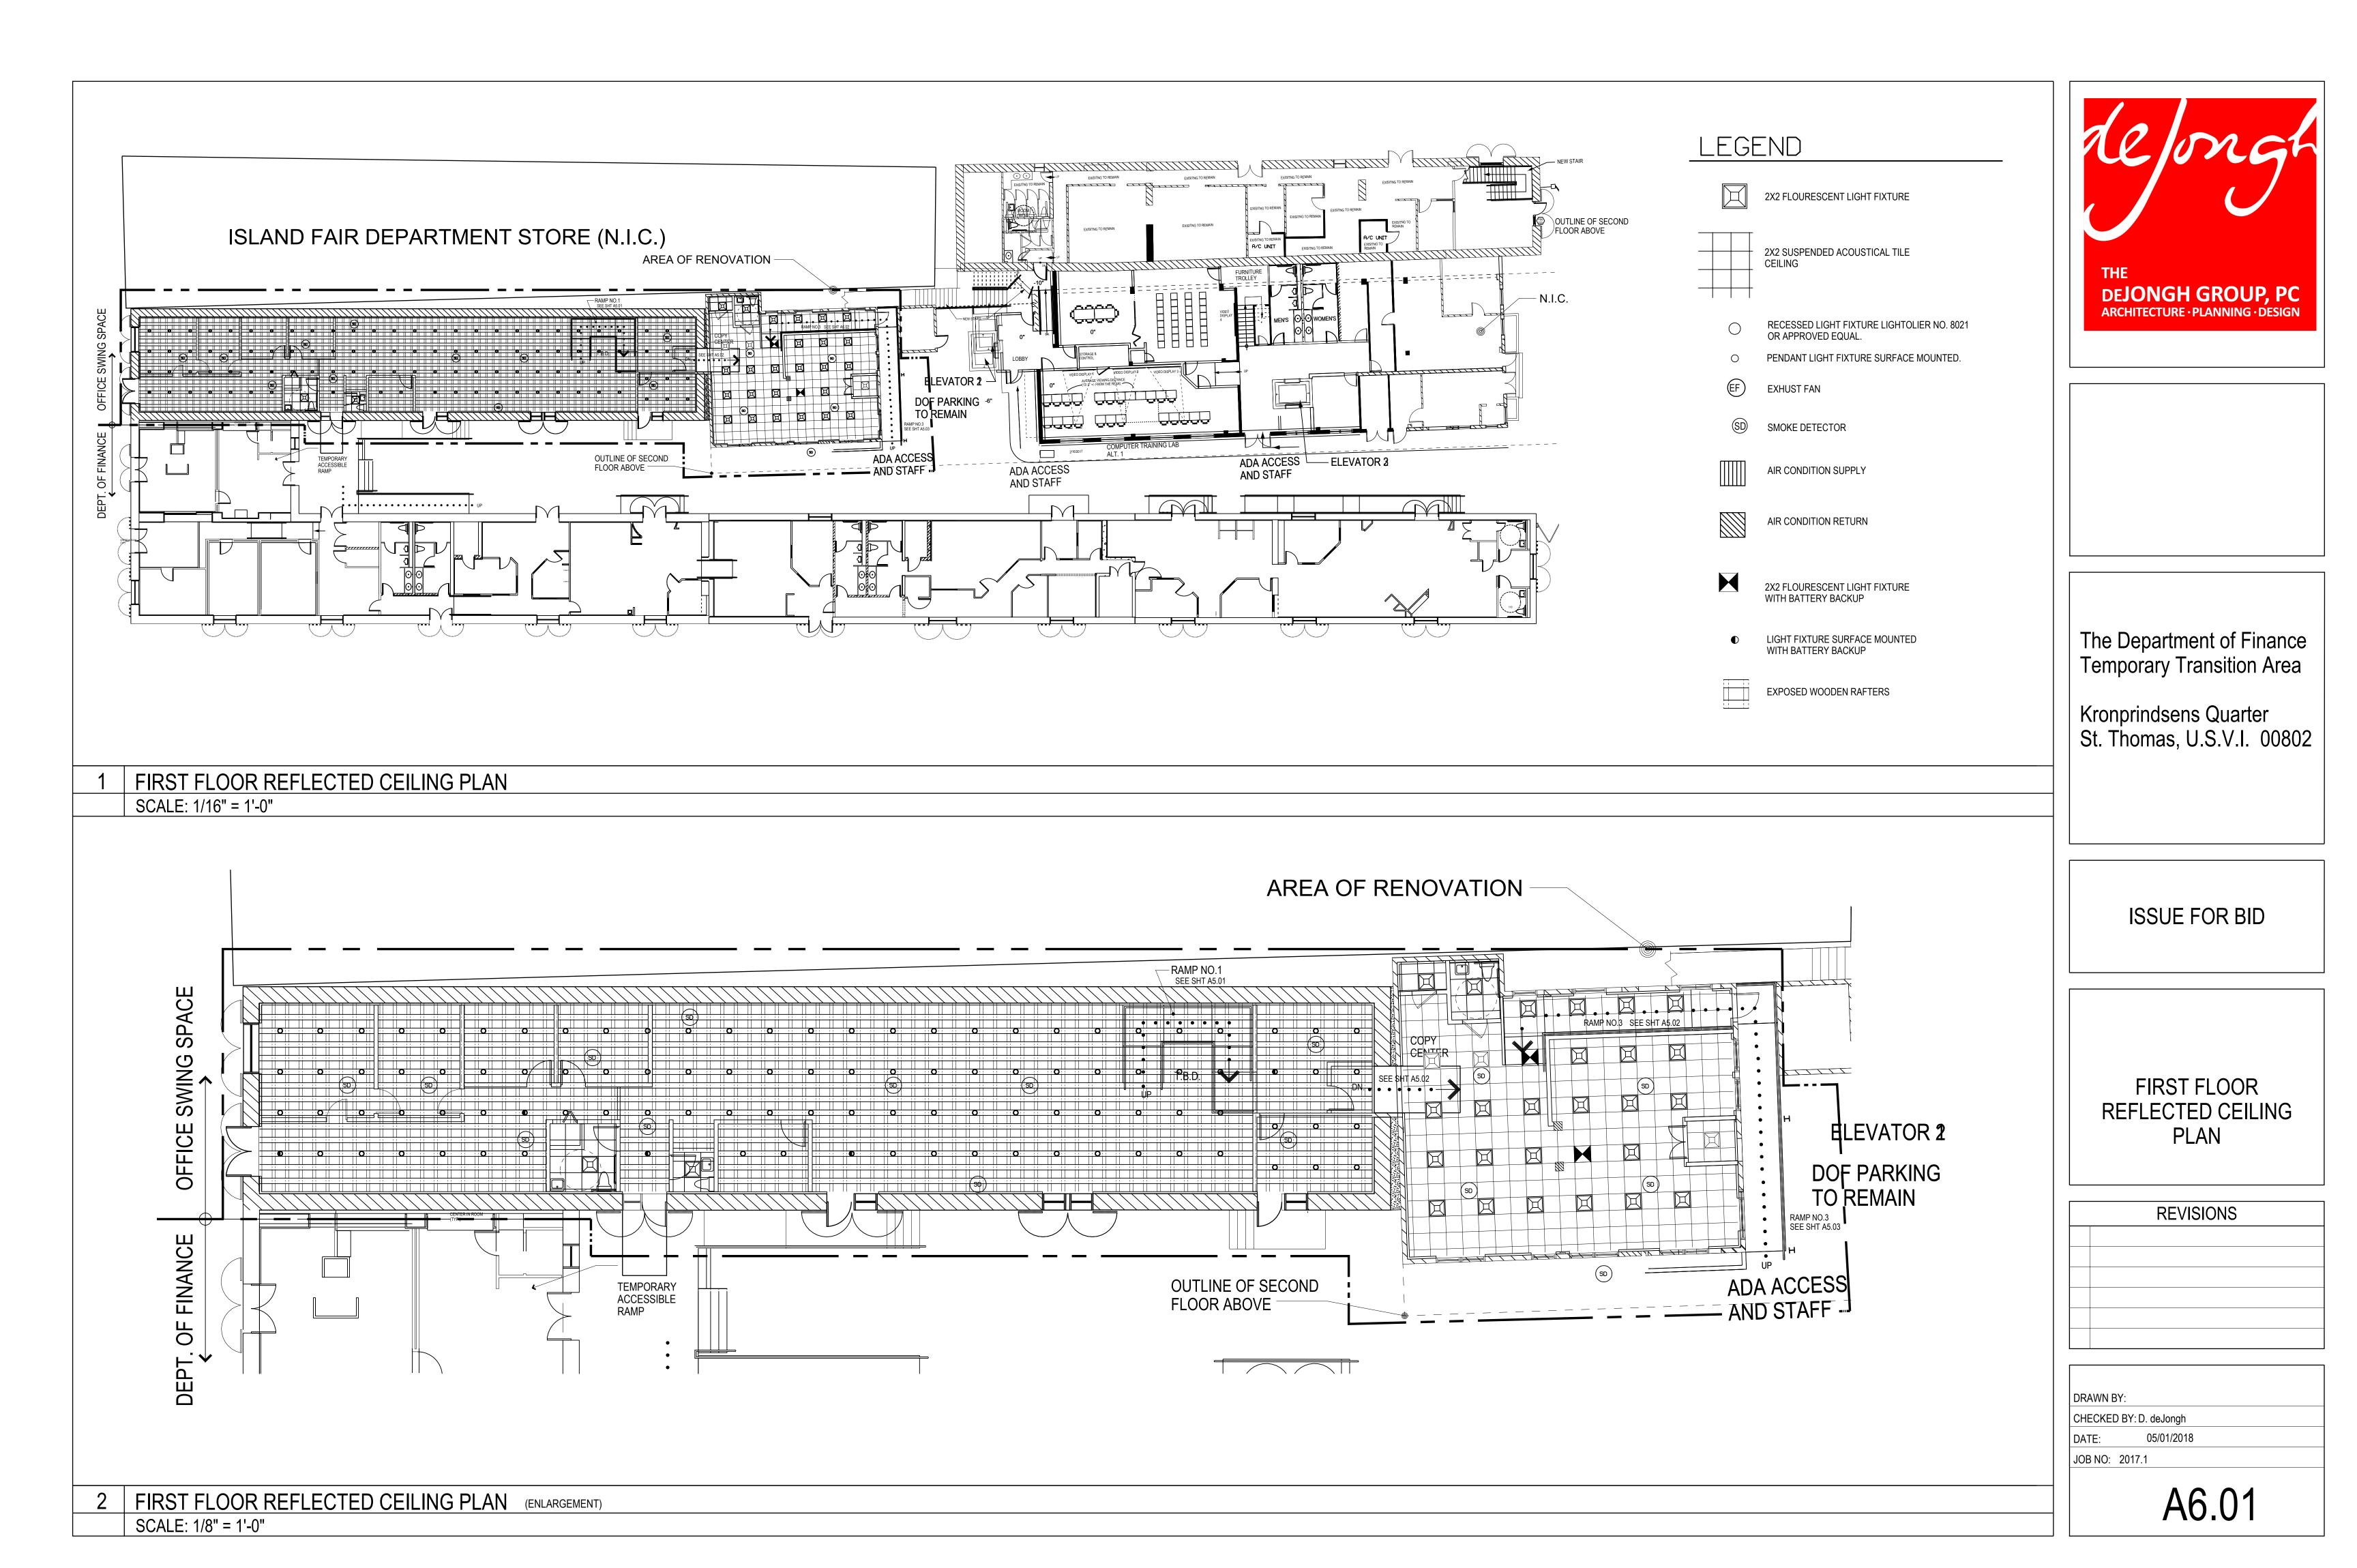

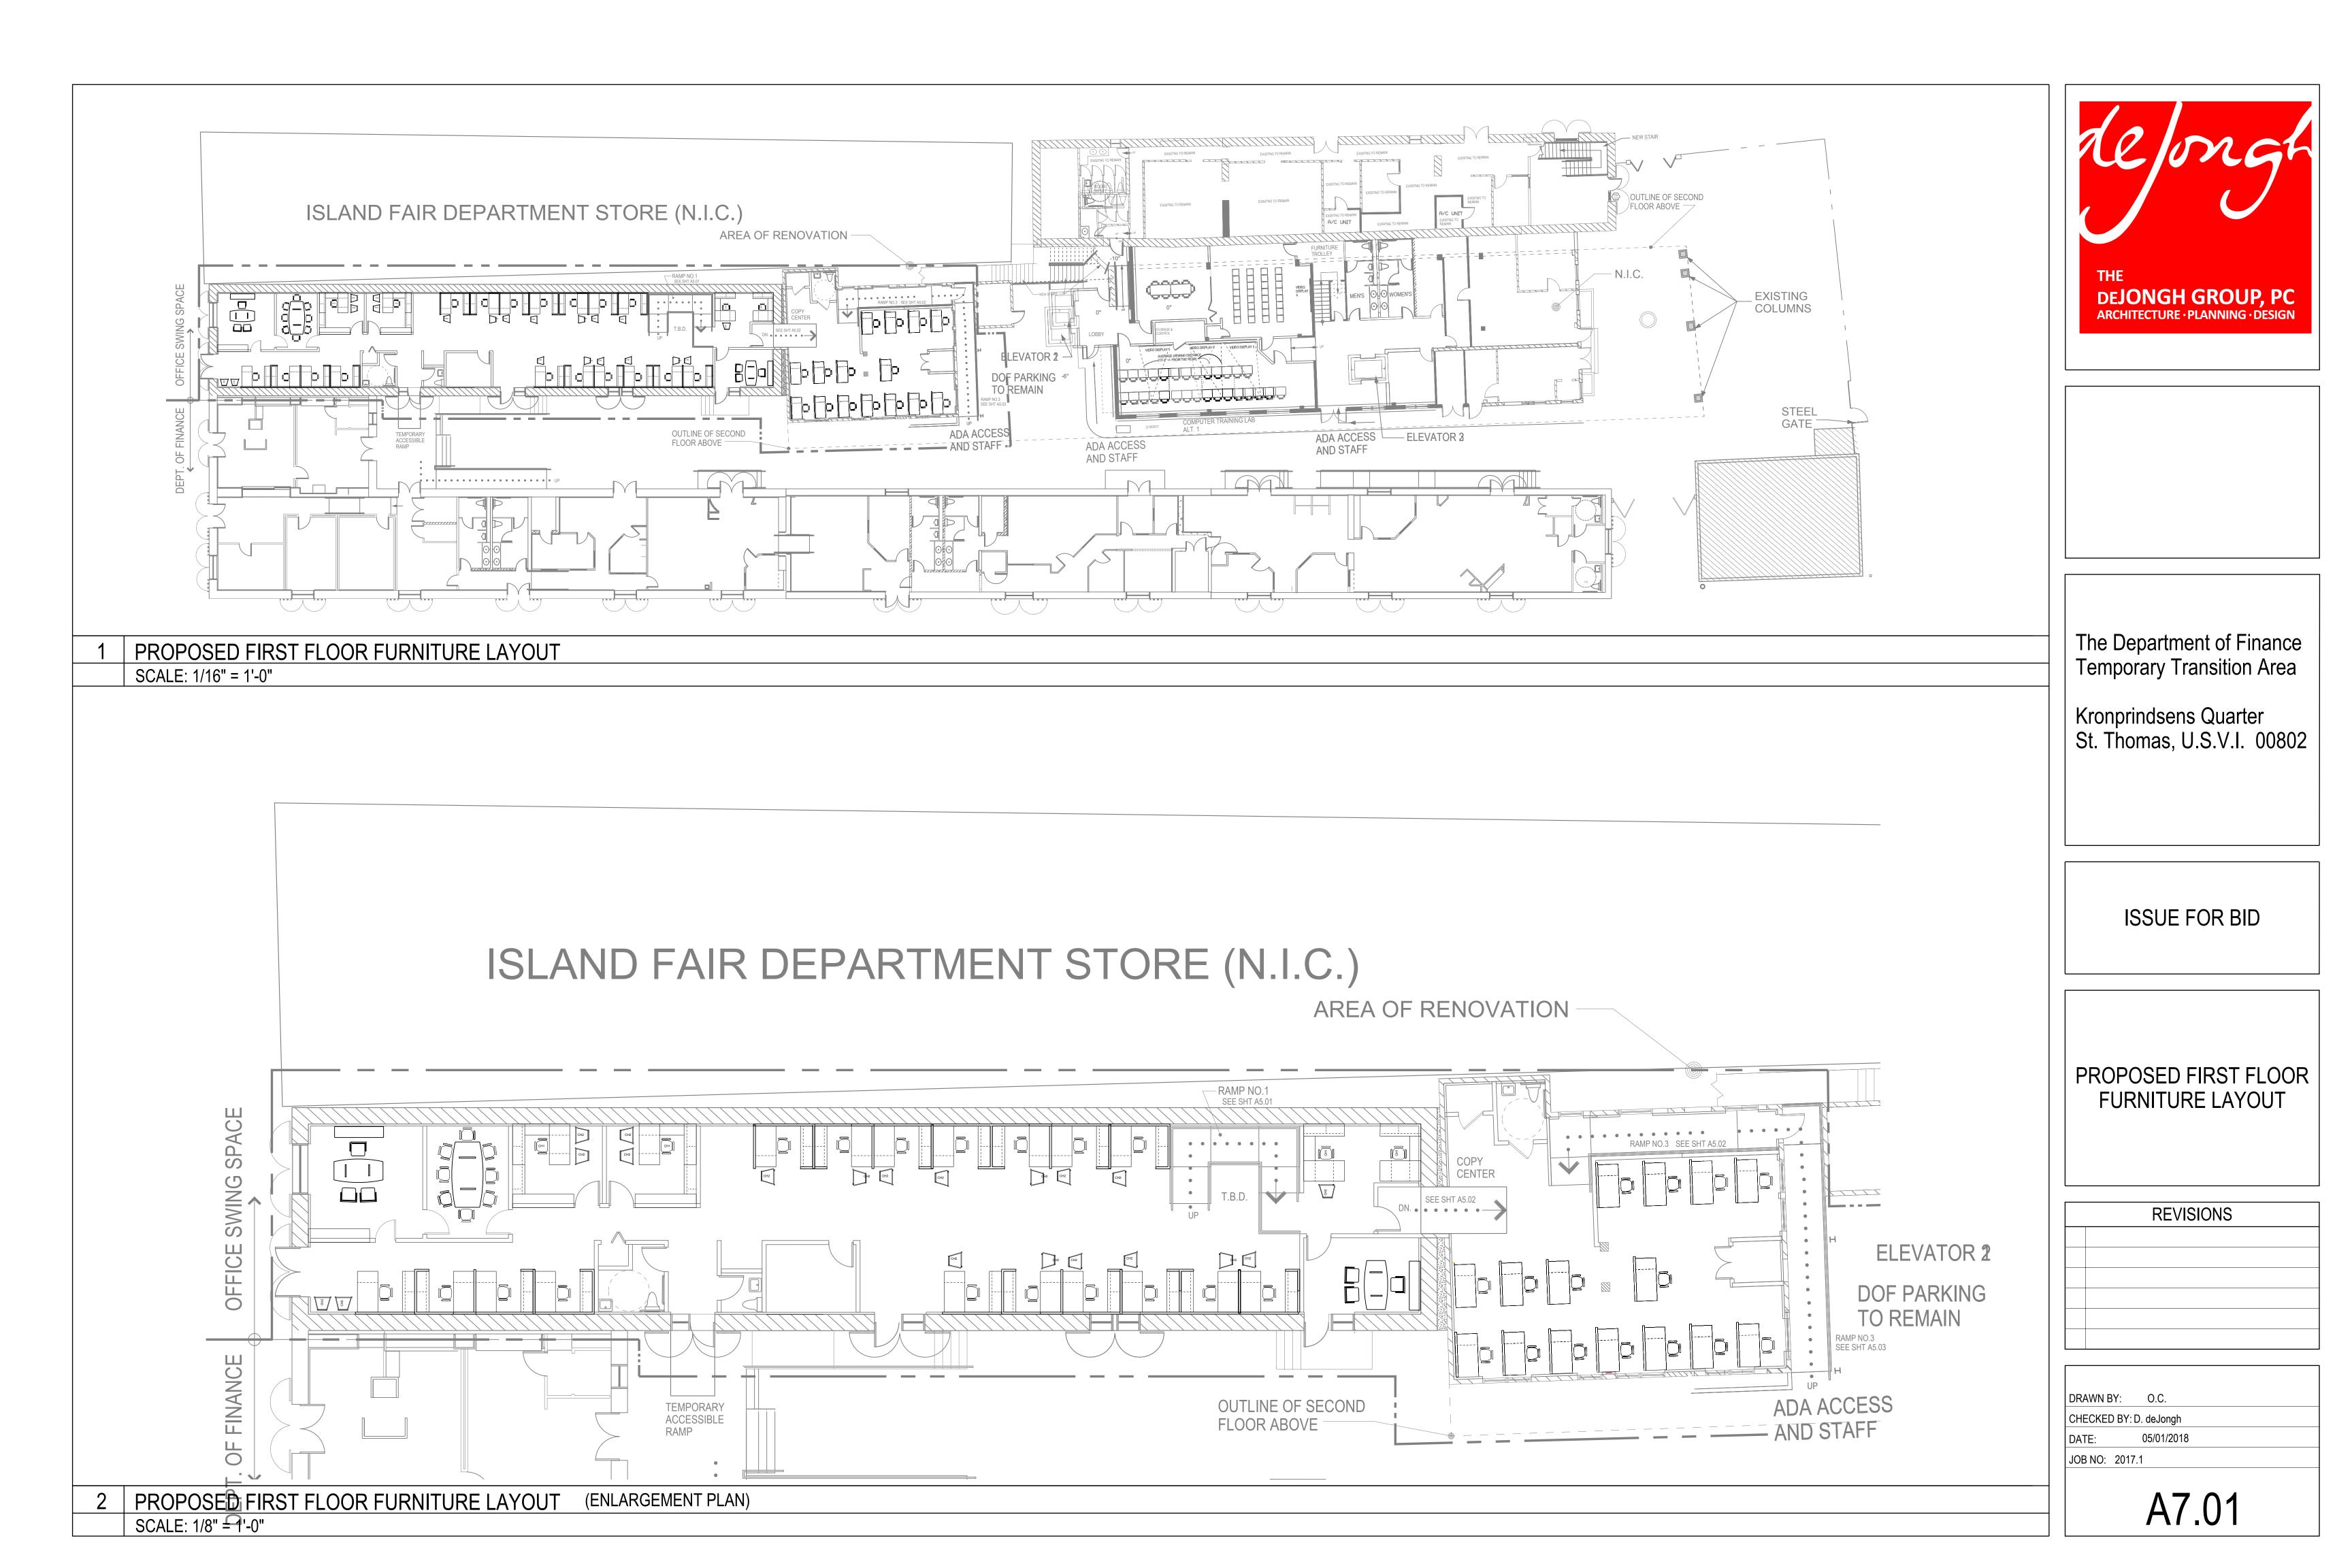

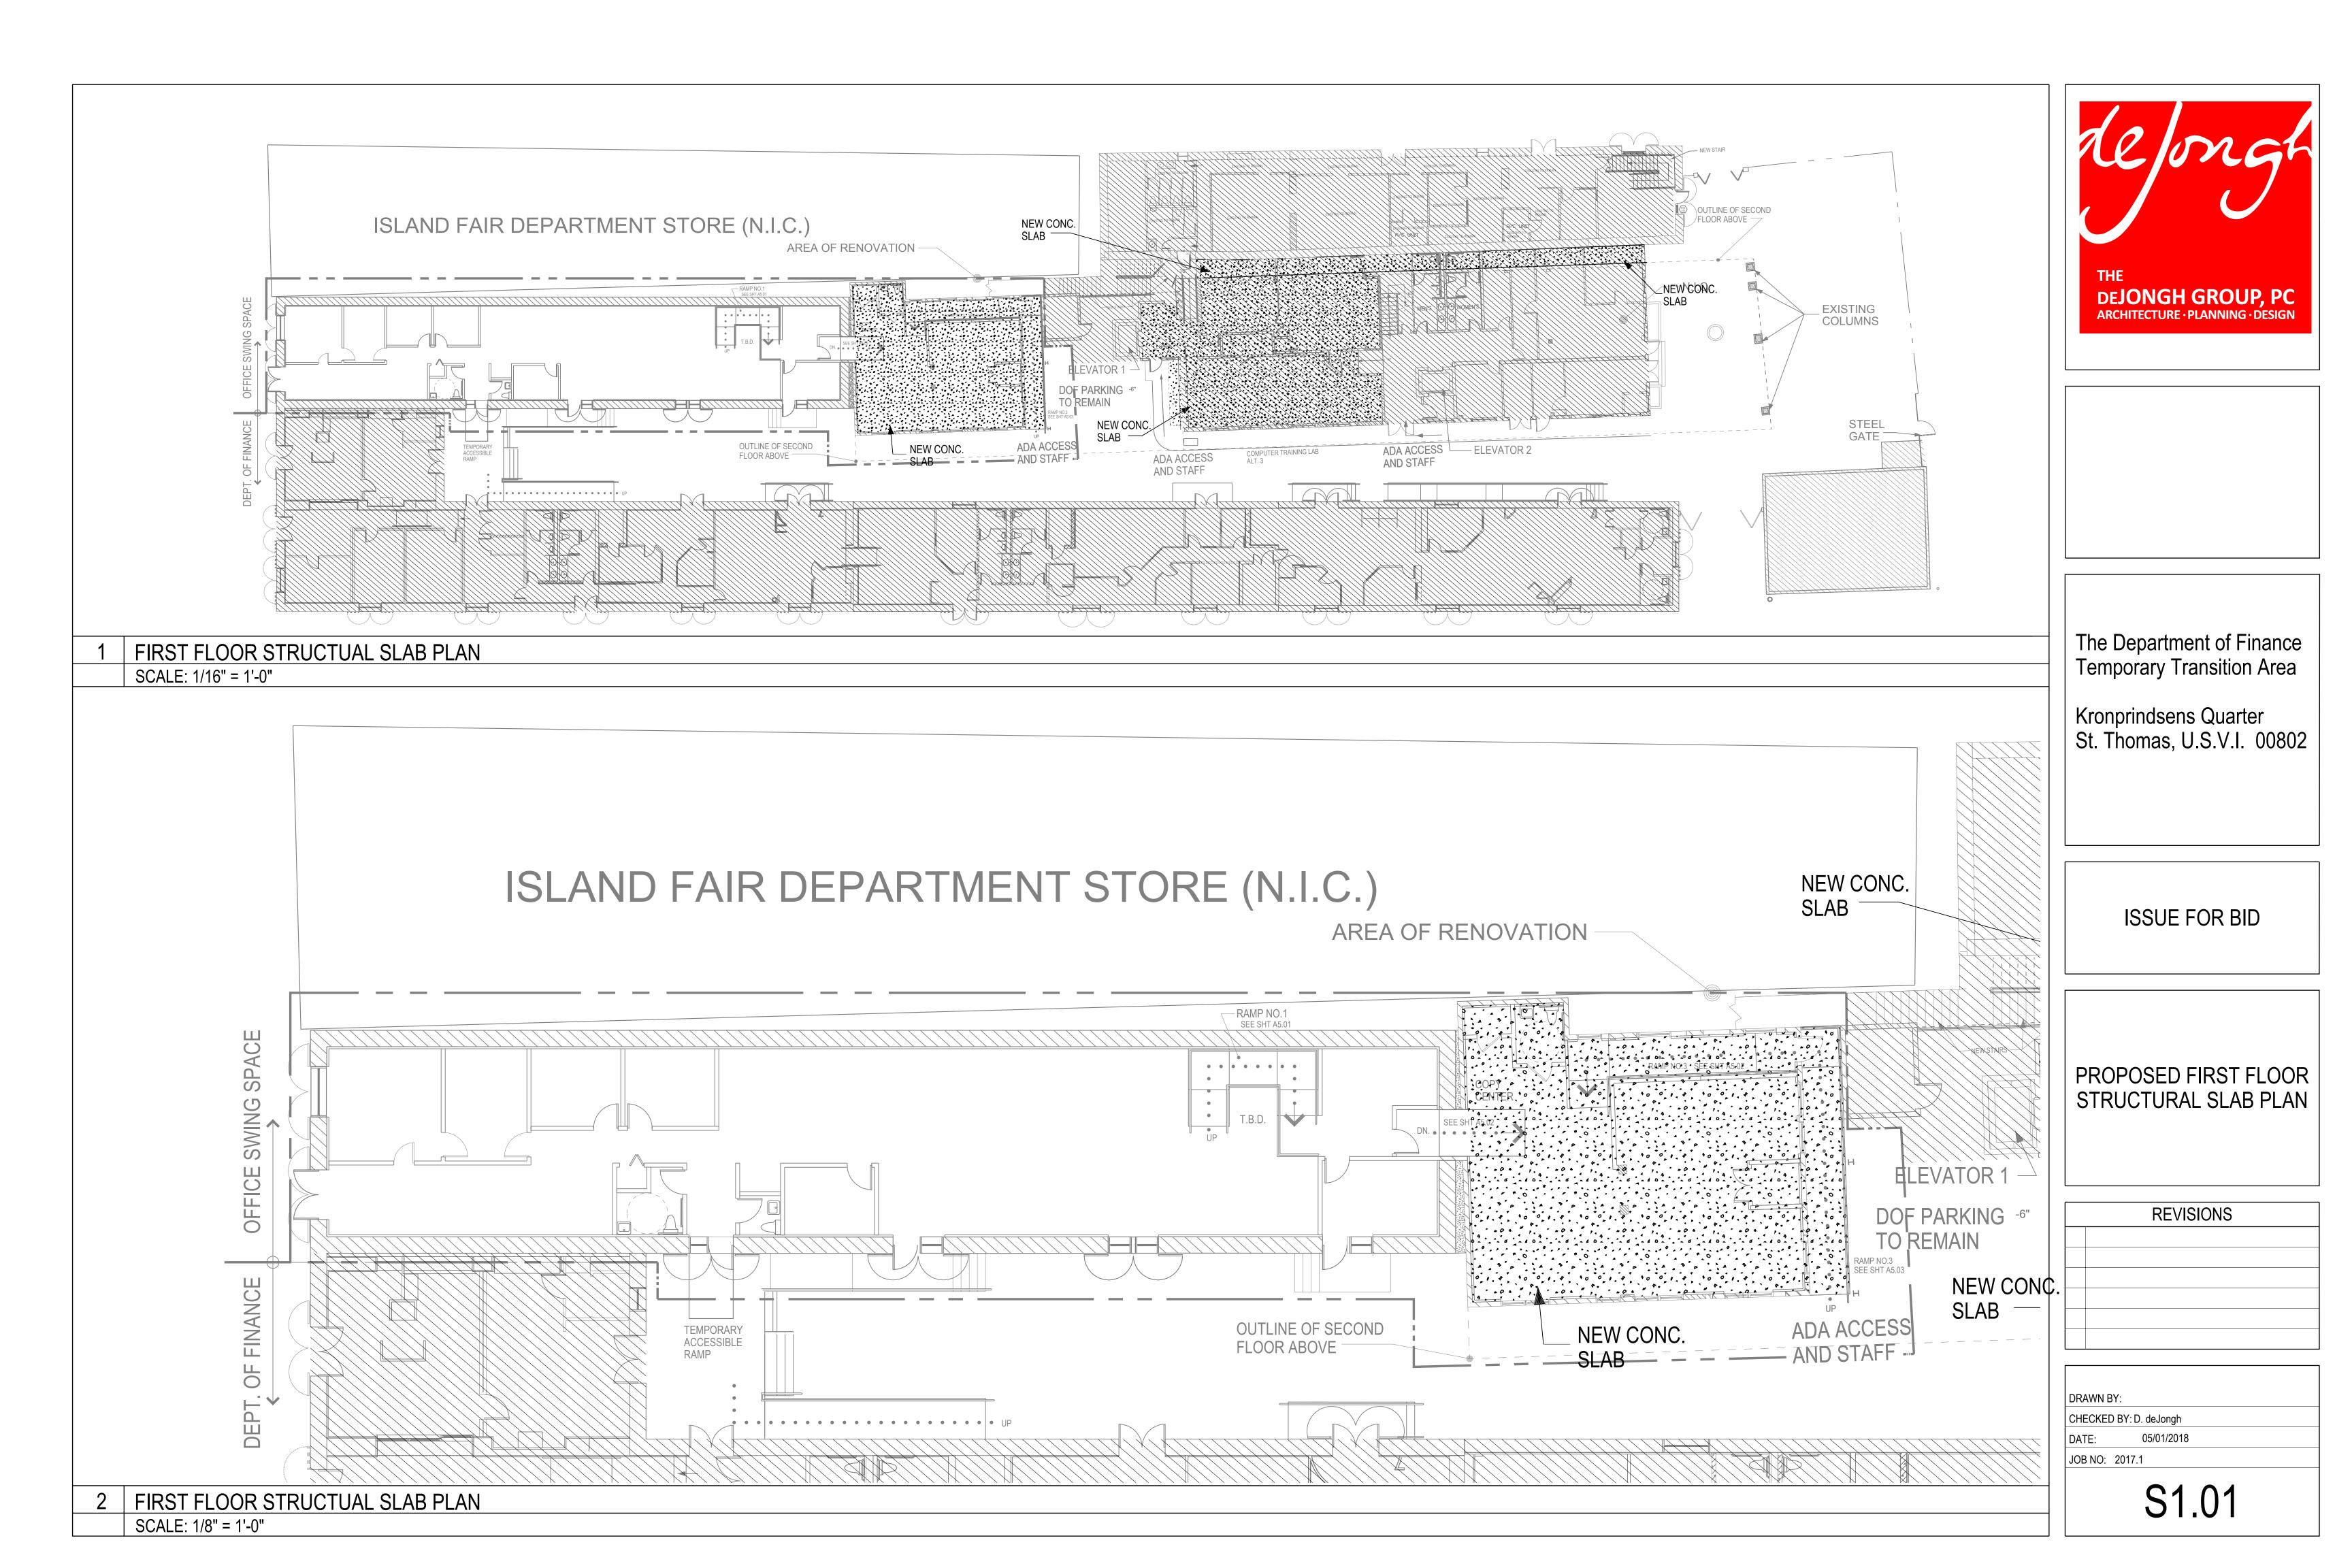

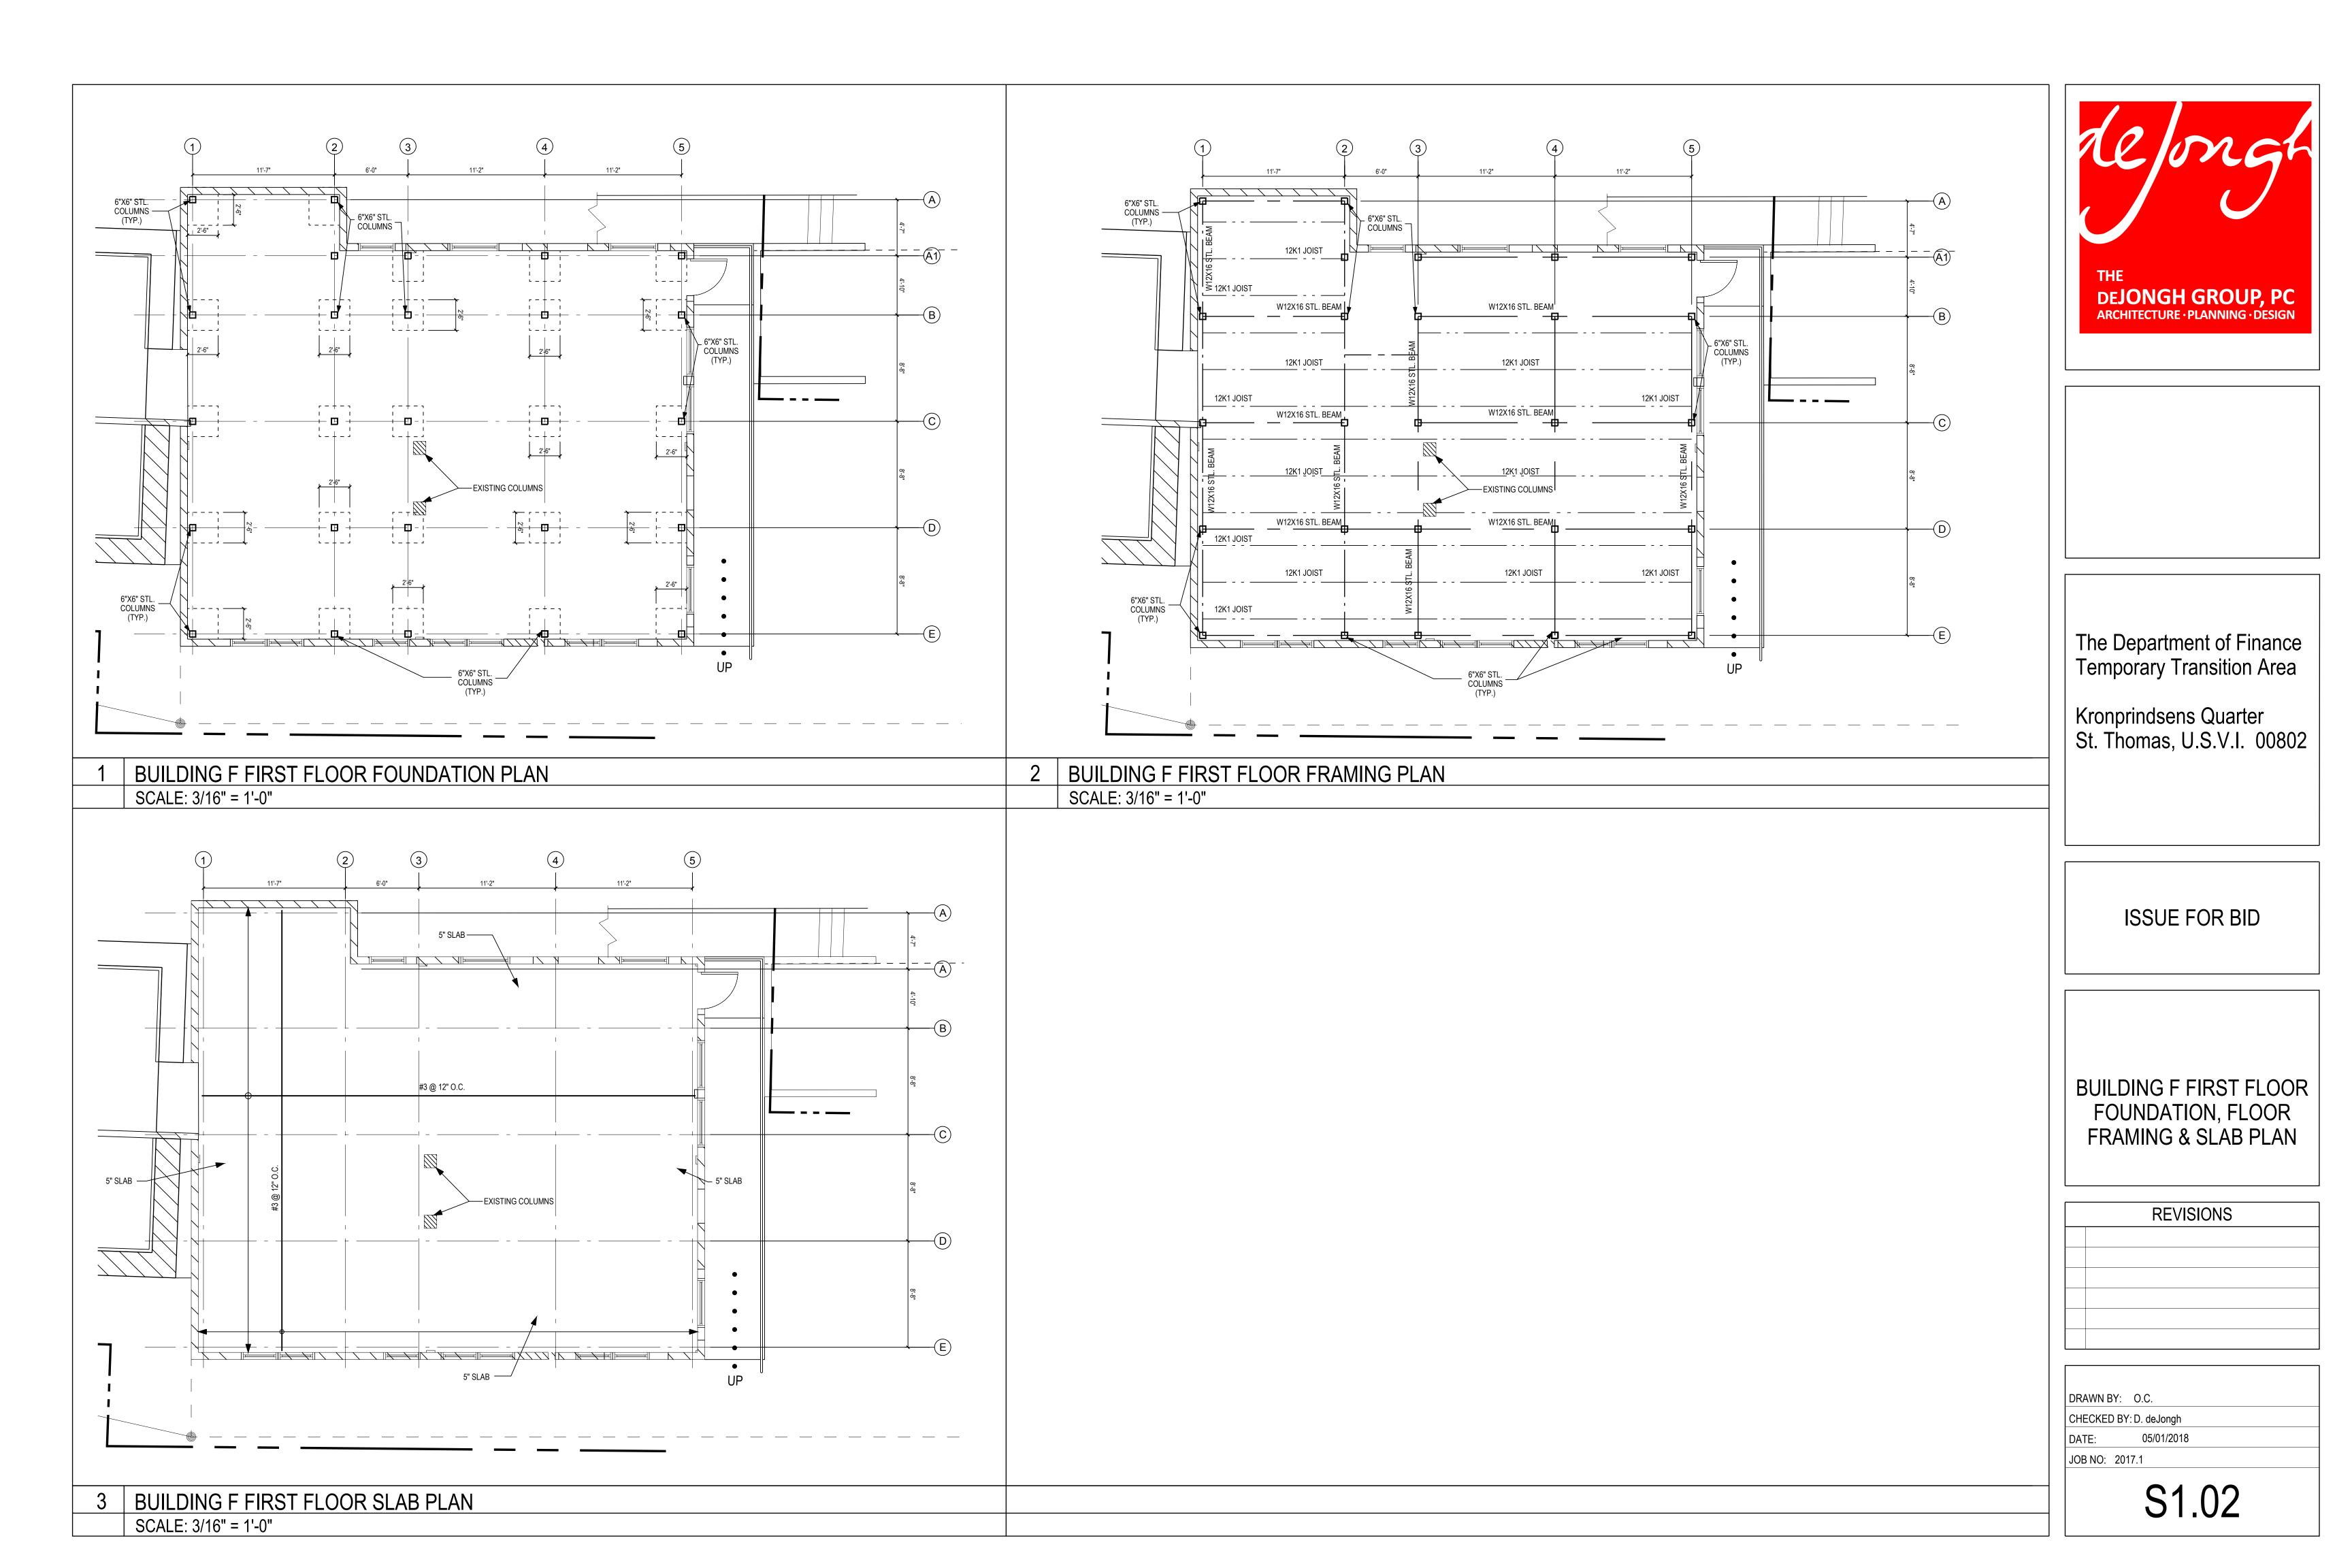

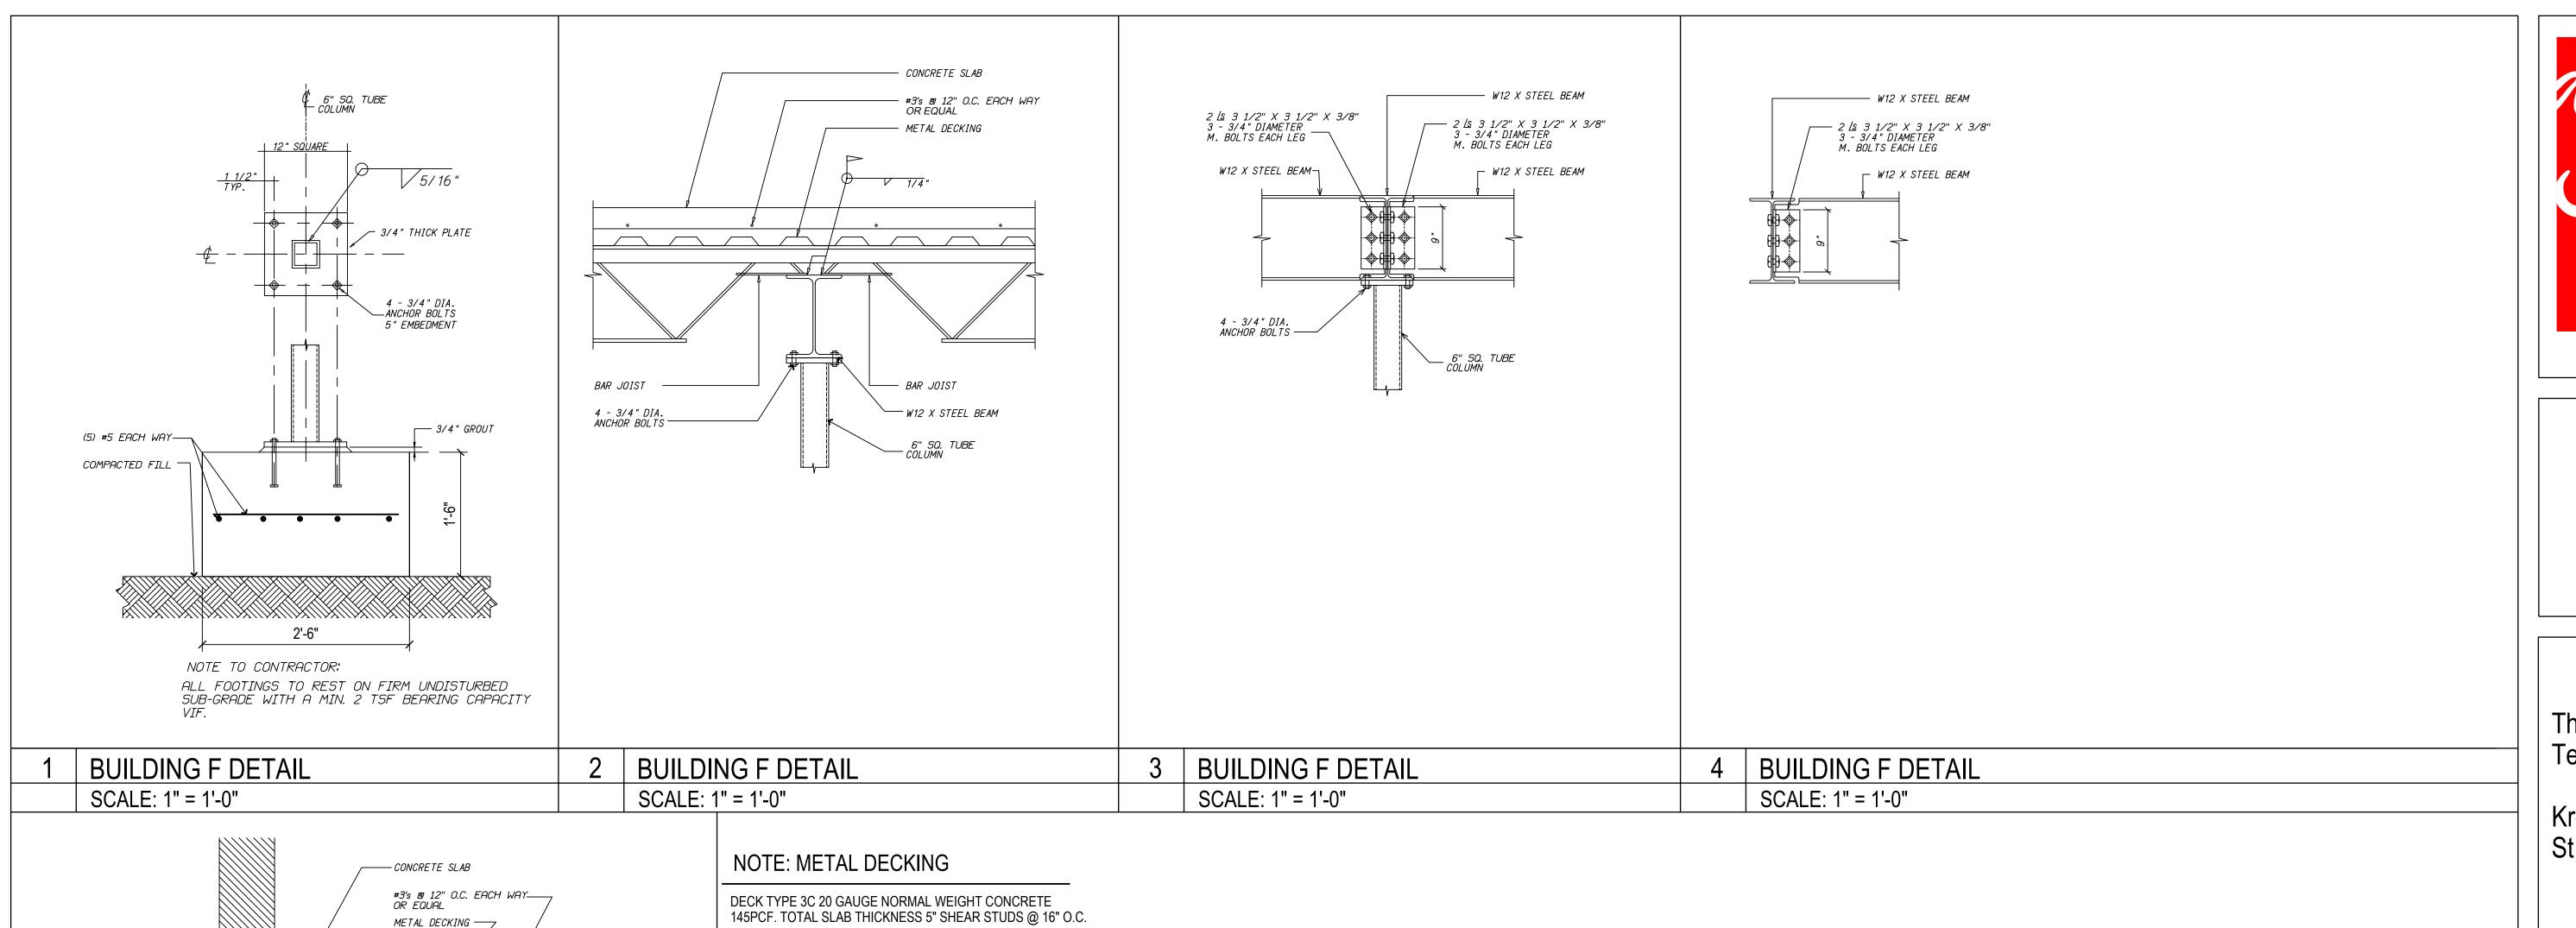



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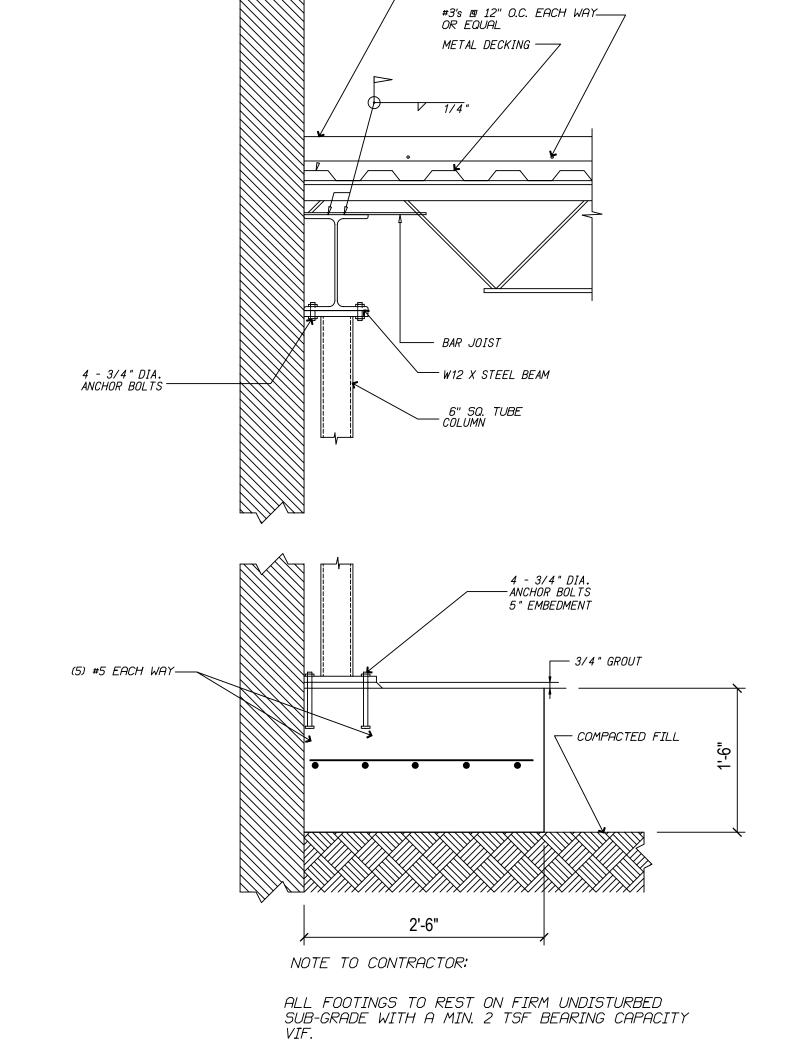
ISSUE FOR BID

BUILDING F FIRST FLOOR DETAILS

**REVISIONS** 


DRAWN BY: O.C. CHECKED BY: D. deJongh 05/01/2018 JOB NO: 2017.1


S1.03



5 BUILDING F DETAIL

SCALE: 1" = 1'-0"

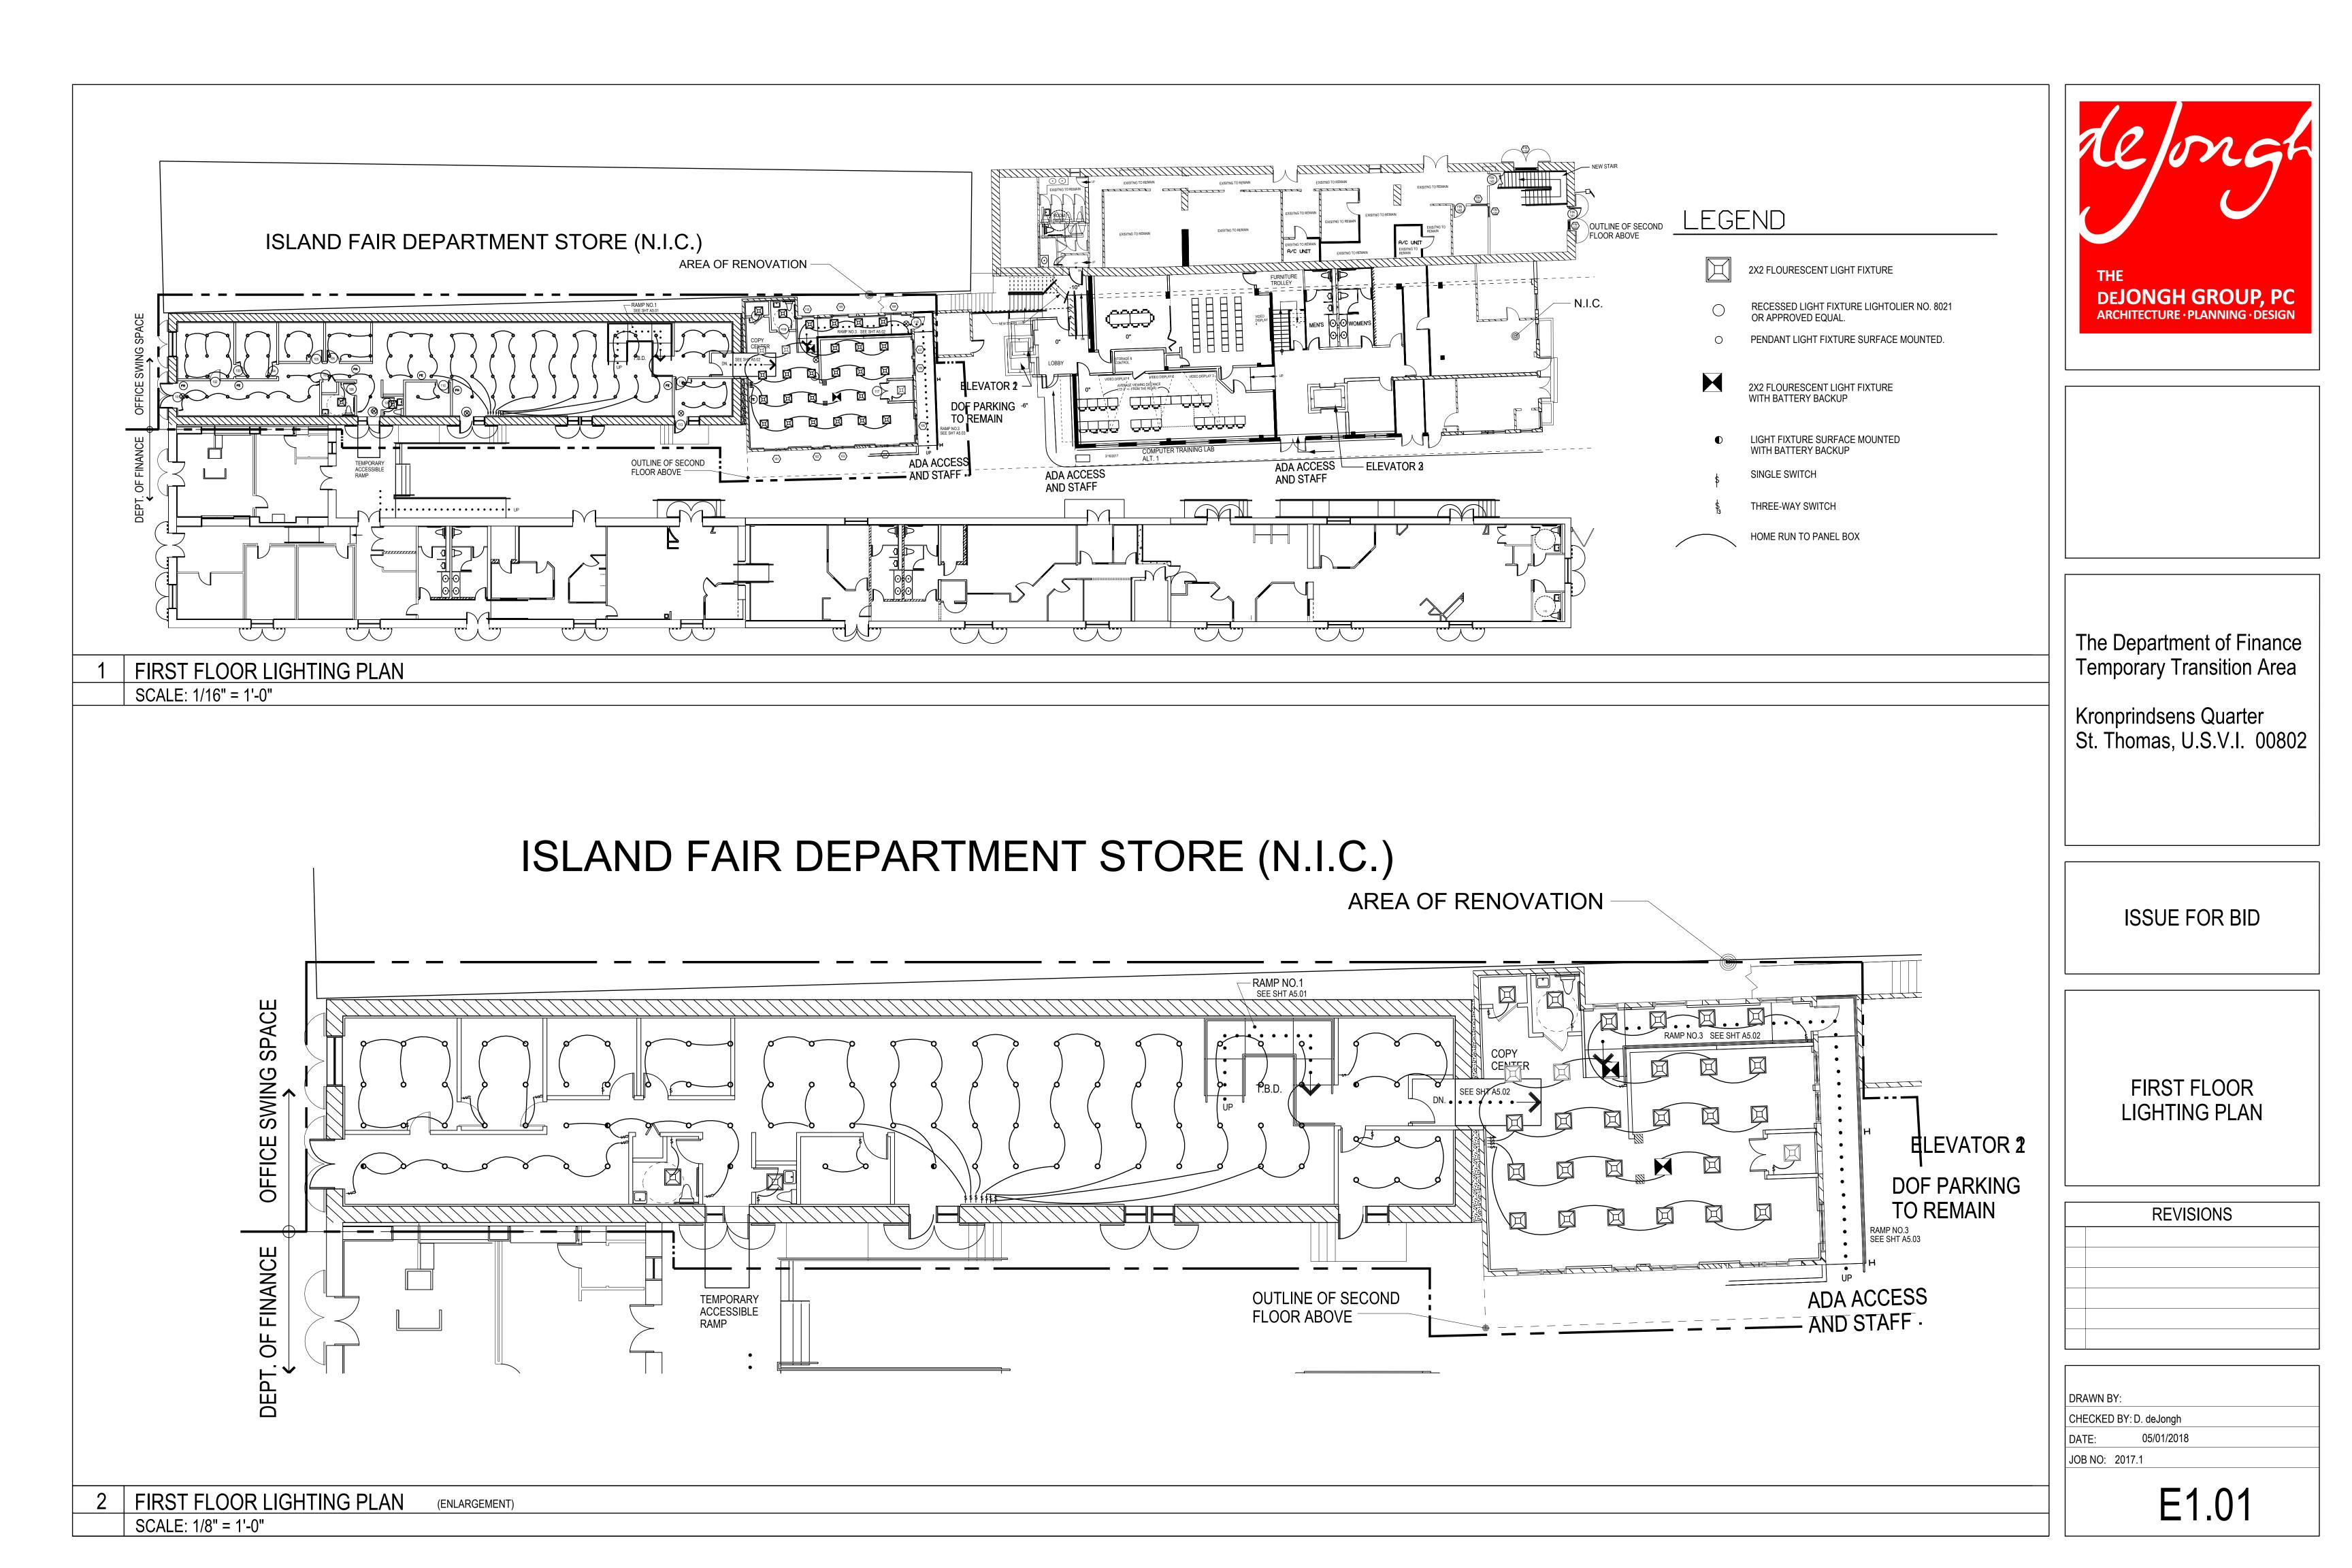

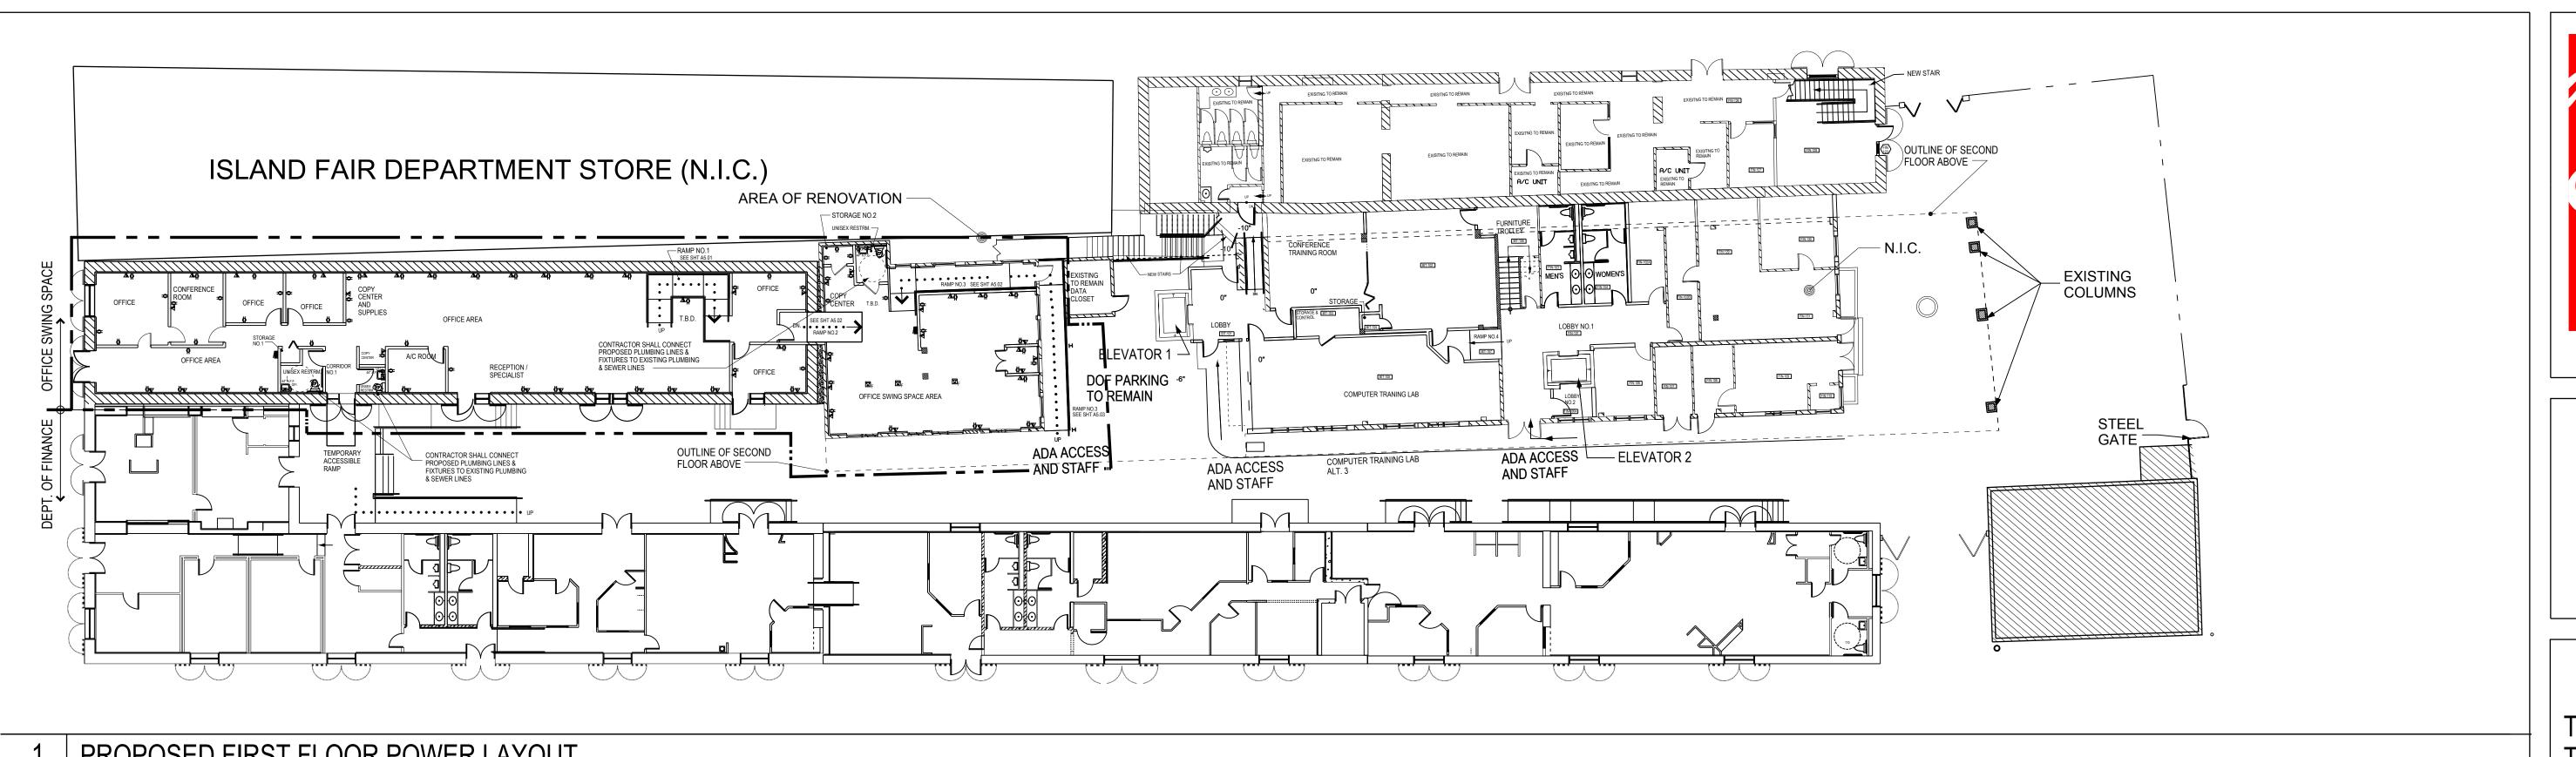

DEJONGH GROUP, PC

ARCHITECTURE · PLANNING · DESIGN

The Department of Finance **Temporary Transition Area** 

Kronprindsens Quarter St. Thomas, U.S.V.I. 00802

ALL CONDUIT SWEEPS SHALL BE IN COMPLIANCE WITH THE

N.E.C. CODE

ISSUE FOR BID

PROPOSED FIRST FLOOR POWER LAYOUT

**REVISIONS** 

DRAWN BY: CHECKED BY: D. deJongh 05/01/2018

JOB NO: 2017.1

E2.01

PROPOSED FIRST FLOOR POWER LAYOUT

SCALE: 1/16" = 1'-0"

	ELECTRICAL LEGEND
	ELECTRICAL PANEL BOX
ф	DUPLEX RECEPTACLE OUTLET
∯ <sub>GFI</sub>	GROUND FAULT INTERRUPTER
lacksquare	TELEPHONE/DATA/ CABLE OUTLET
EF	EXHAUST FAN
$\square_{F}$	TELEPHONE/DATA/ CABLE OUTLET IN FLOOR

# GENERAL ELECTRICAL NOTES:

- ALL ELECTRICAL WORK SHALL BE COMPLETED IN STRICT ACCORDANCE WITH THE LATE EDITION OF THE N.E.C.
- THE ELECTRICIAN SHALL OBTAIN ALL PERMITS AND PAY ALL FEES RELATED TO HIS WORK.
- ALL WIRING SHALL BE COPPER #12 OR LARGER. ALUMINUM WIRE IS NOT ACCEPTABLE.
- WIRE TYPE AWG IS PREFERRED.
- ALL WIRING SPLICES SHALL BE MADE USING 3M ELECTRICAL SPRING CONNECTORS OR EQUAL "TWIST-ONS" TO CORRECT SIZE. WIRE TAPED OR TWISTED IS NOT ACCEPTABLE.

ALL CONDUITS INSTALLED IN CONCRETE OR MASONRY SHALL BE RIGID NON-METALLIC TYPE (P.V.C.). ALL OUTLETS AND SWITCH BOXES SHALL BE NON-METALLIC TYPE.

GROUNDING CONDUCTORS SHALL BE CONNECTED TO NEUTRAL CONDUCTORS AT THE SERVICE ENTRANCE ONLY. CERTAIN EXCEPYIONS AS PERMITTED BY THE N.B.C. SHALL BE PERMITTED.


ELECTRICAL SYSTEM LAYOUT INDICATED ON DRAWINGS ARE GENERALLY DIAGRAMMATIC AND LOCATION OF OUTLETS AND EQUIPMENT ARE APPROXIMATE; ROUTING OF RACEWAYS AND LOCATION OF OUTLETS AND EQUIPMENT SHALL BE GOVERNED BY STRUCTURAL CONDITIONS AND OBSTRUCTIONS.


INCOMING POWER IS 208Y/120VOLTS WITH 1200 AMPS SERVICE DISCONNECT.


GFF AF.E. EF - RAMP NO.1 SEE SHT A5.01 TO REMAIN CONFERENCE DATA CENTER ROOM CLOSET **A**  $\phi$ CENTER T.B.D. OFFICE AND SUPPLIES T.B.D. OFFICE AREA SEE SHT A5.02 RAMP NO.2 CONTRACTOR SHALL CONNECT **A** () **A** PROPOSED PLUMBING LINES & **ELEVATOR 1** FIXTURES TO EXISTING PLUMBING & SEWER LINES OFFICE AREA RECEPTION / SPECIALIST OFFICE DOF PARKING TO REMAIN OFFICE SWING SPACE AREA RAMP NO.3 SEE SHT A5.03 ADA ACCESS OUTLINE OF SECOND **TEMPORARY** CONTRACTOR SHALL CONNECT **ACCESSIBLE** FLOOR ABOVE PROPOSED PLUMBING LINES & FIXTURES TO EXISTING PLUMBING & SEWER LINES


2 PROPOSED FIRST FLOOR POWER LAYOUT (ENLARGEMENT)


SCALE: 1/8" = 1'-0"

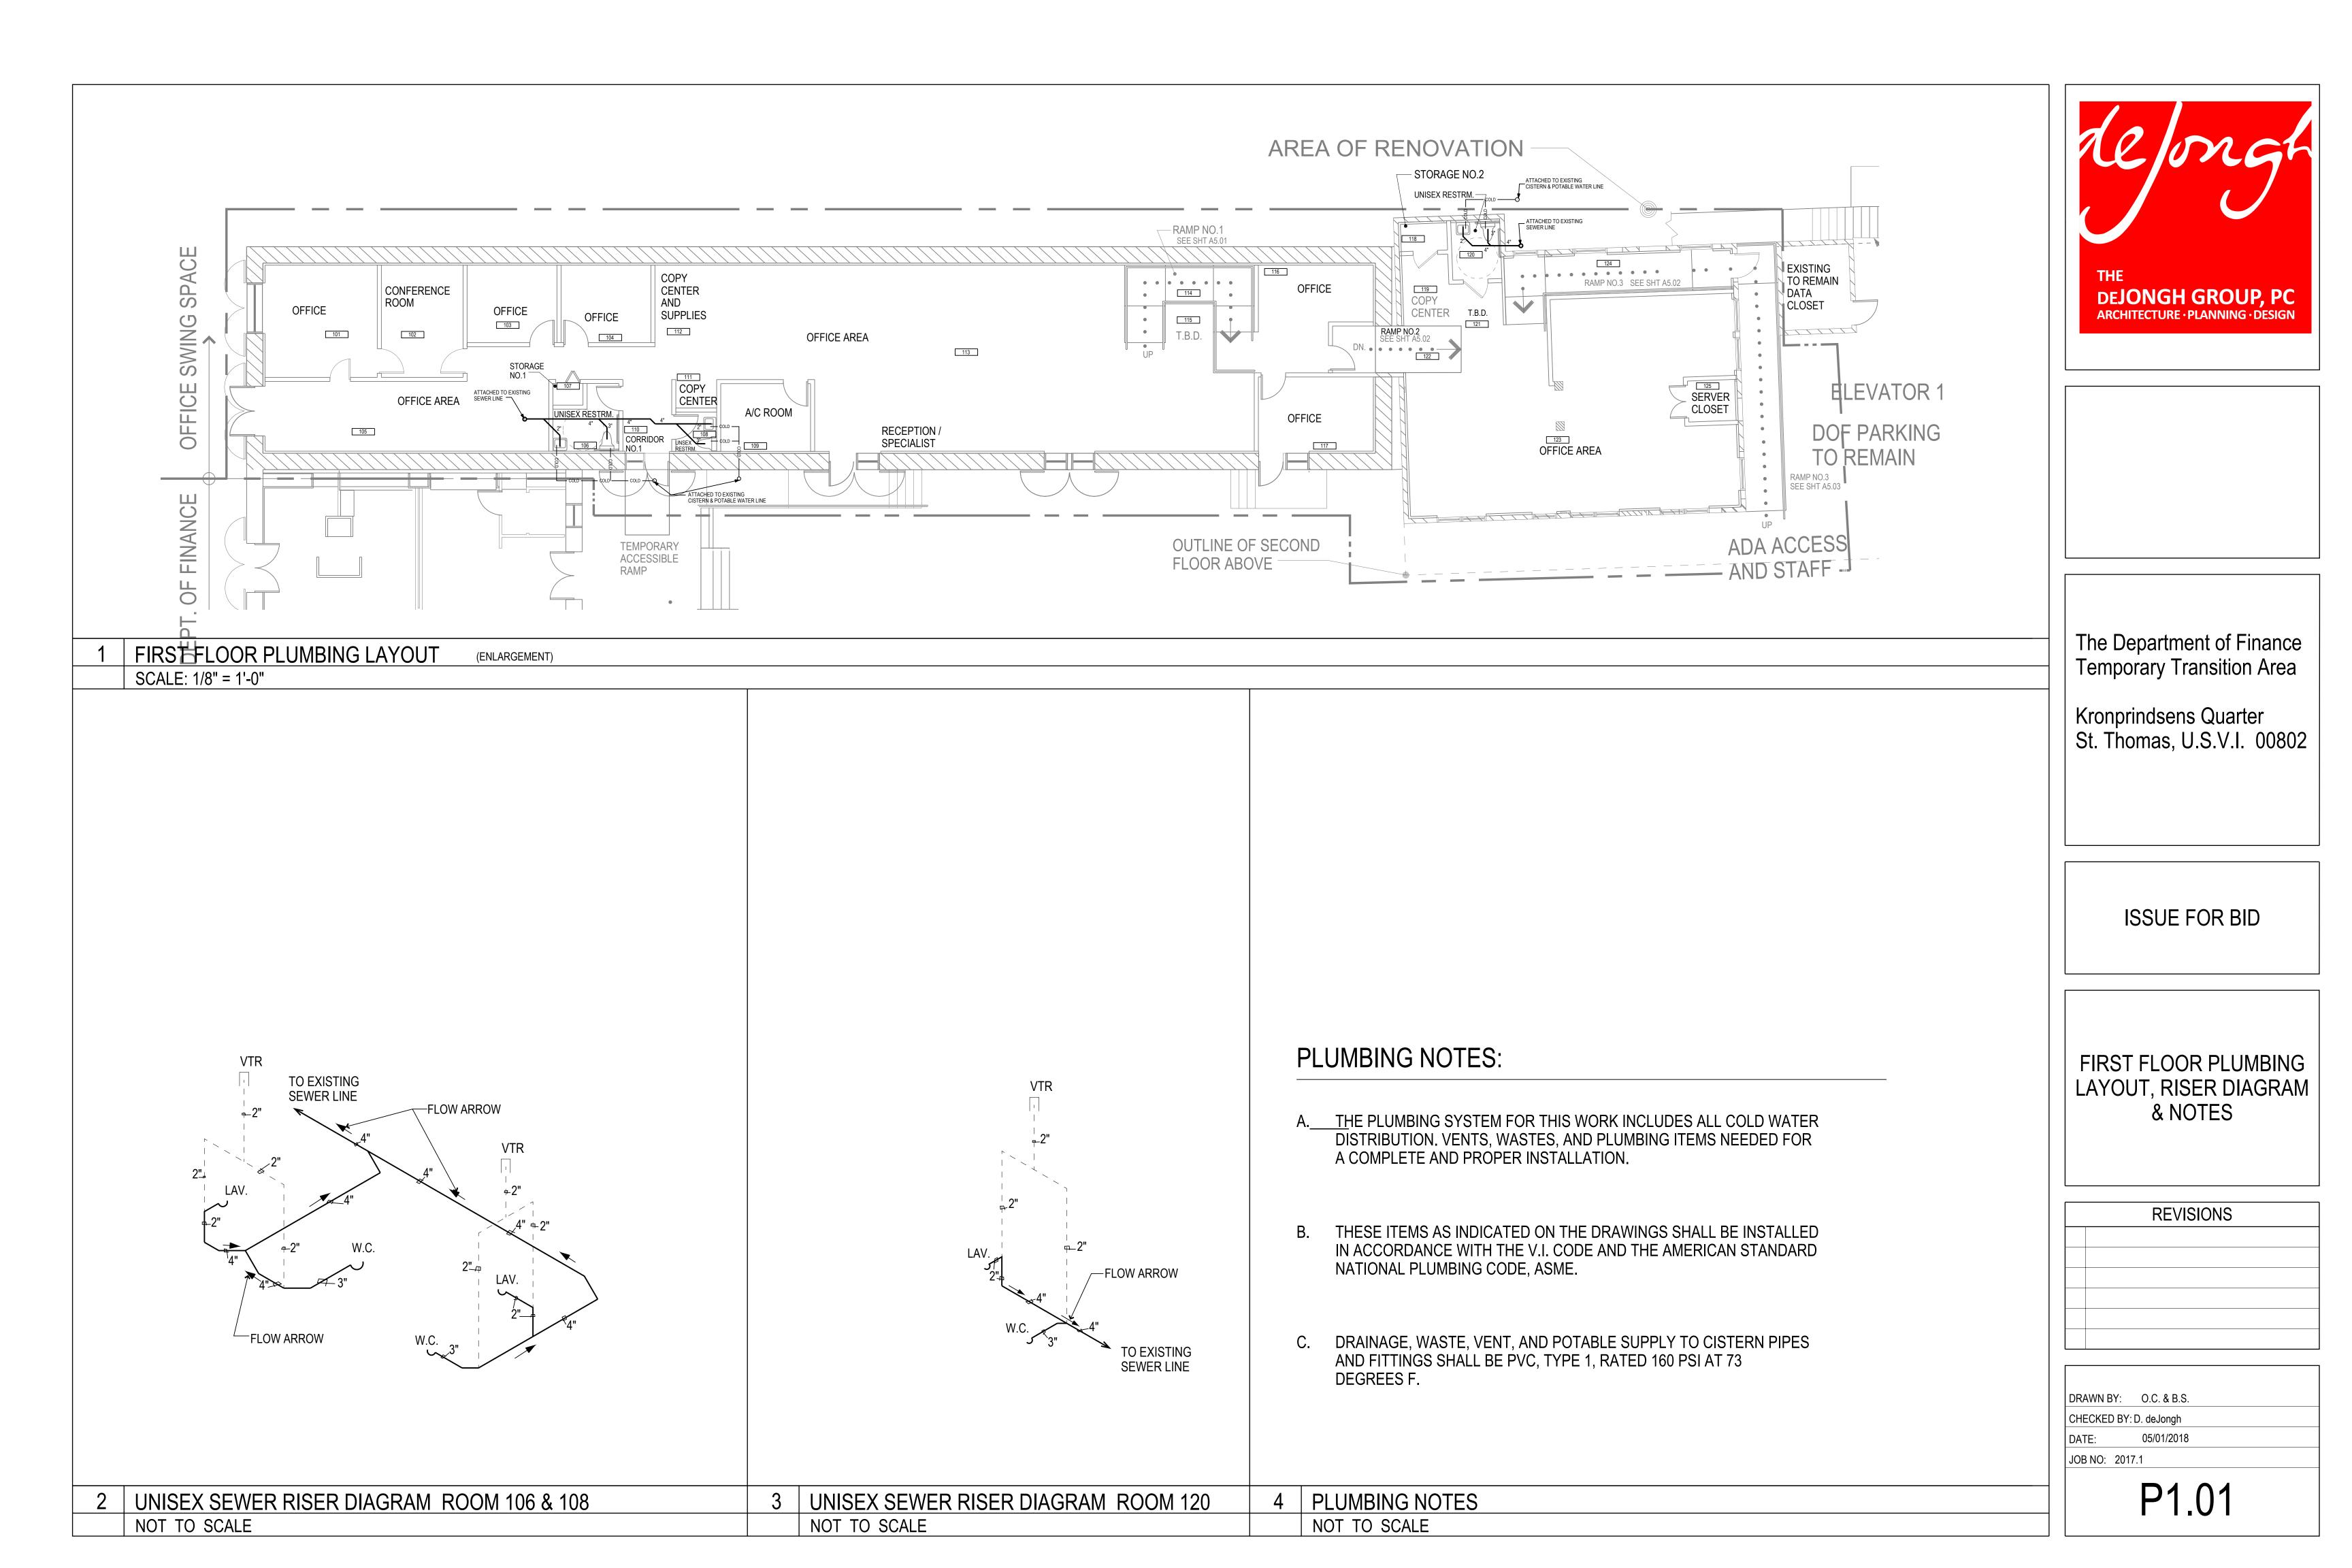


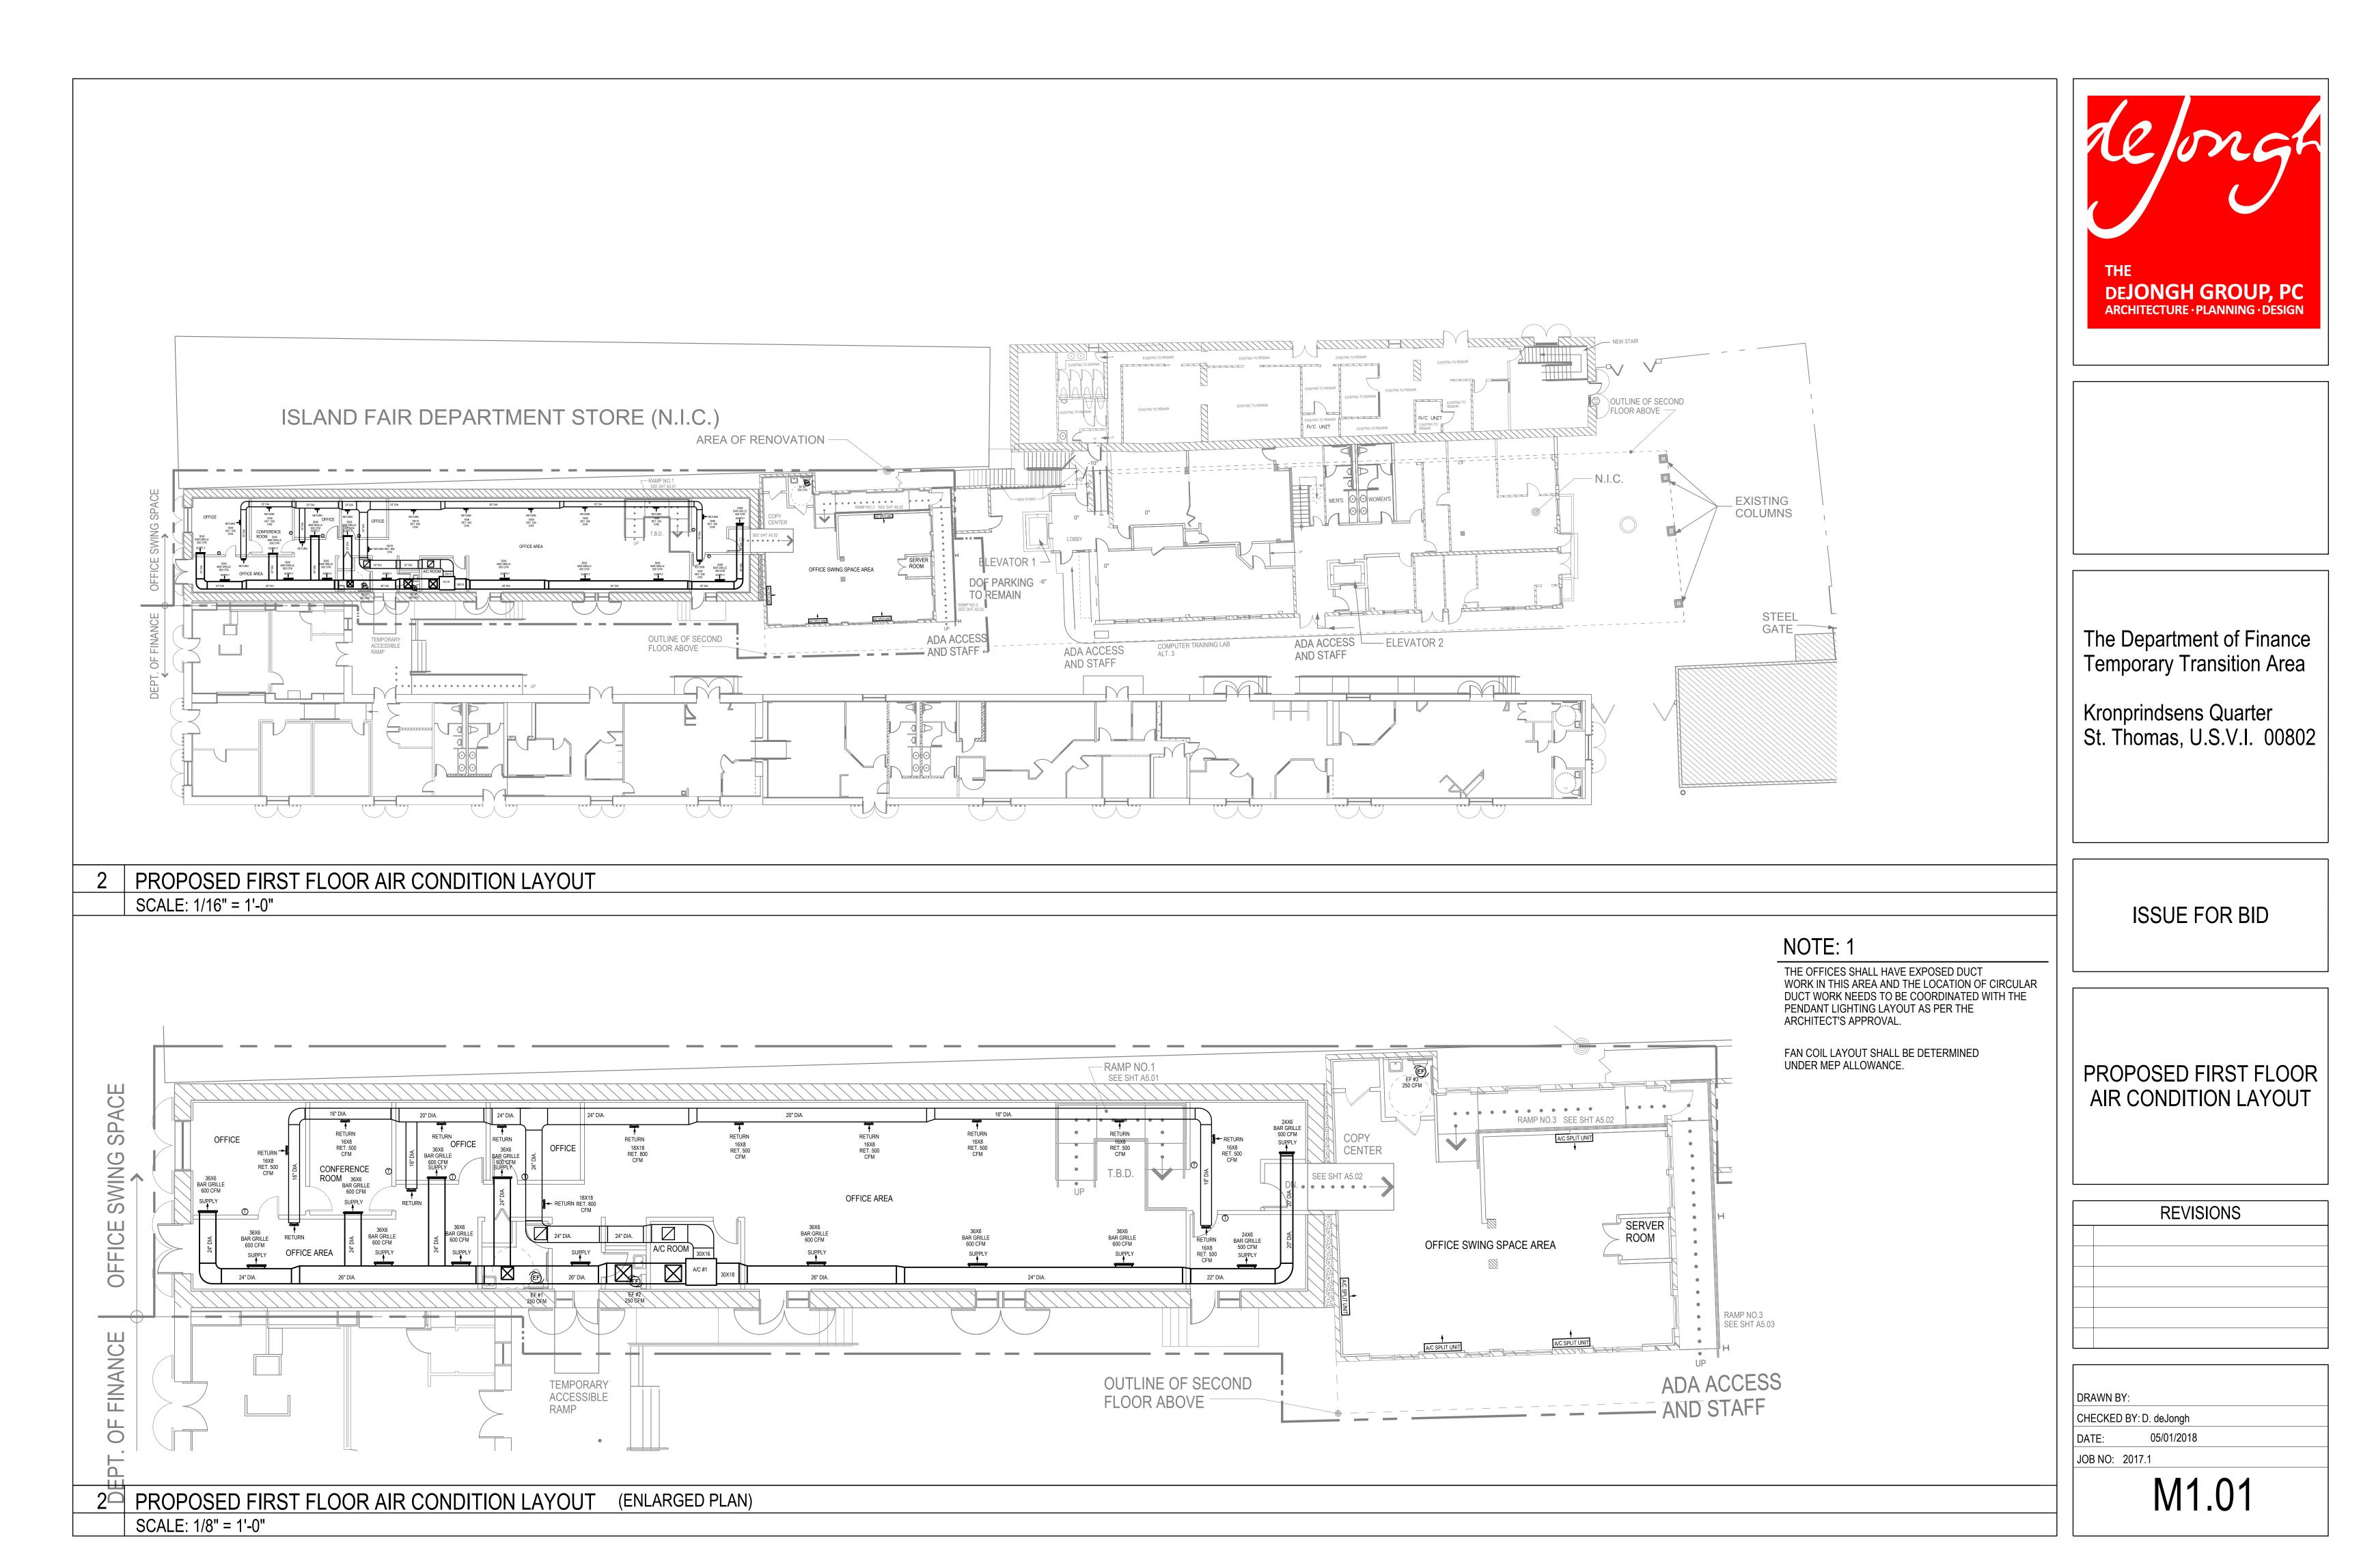


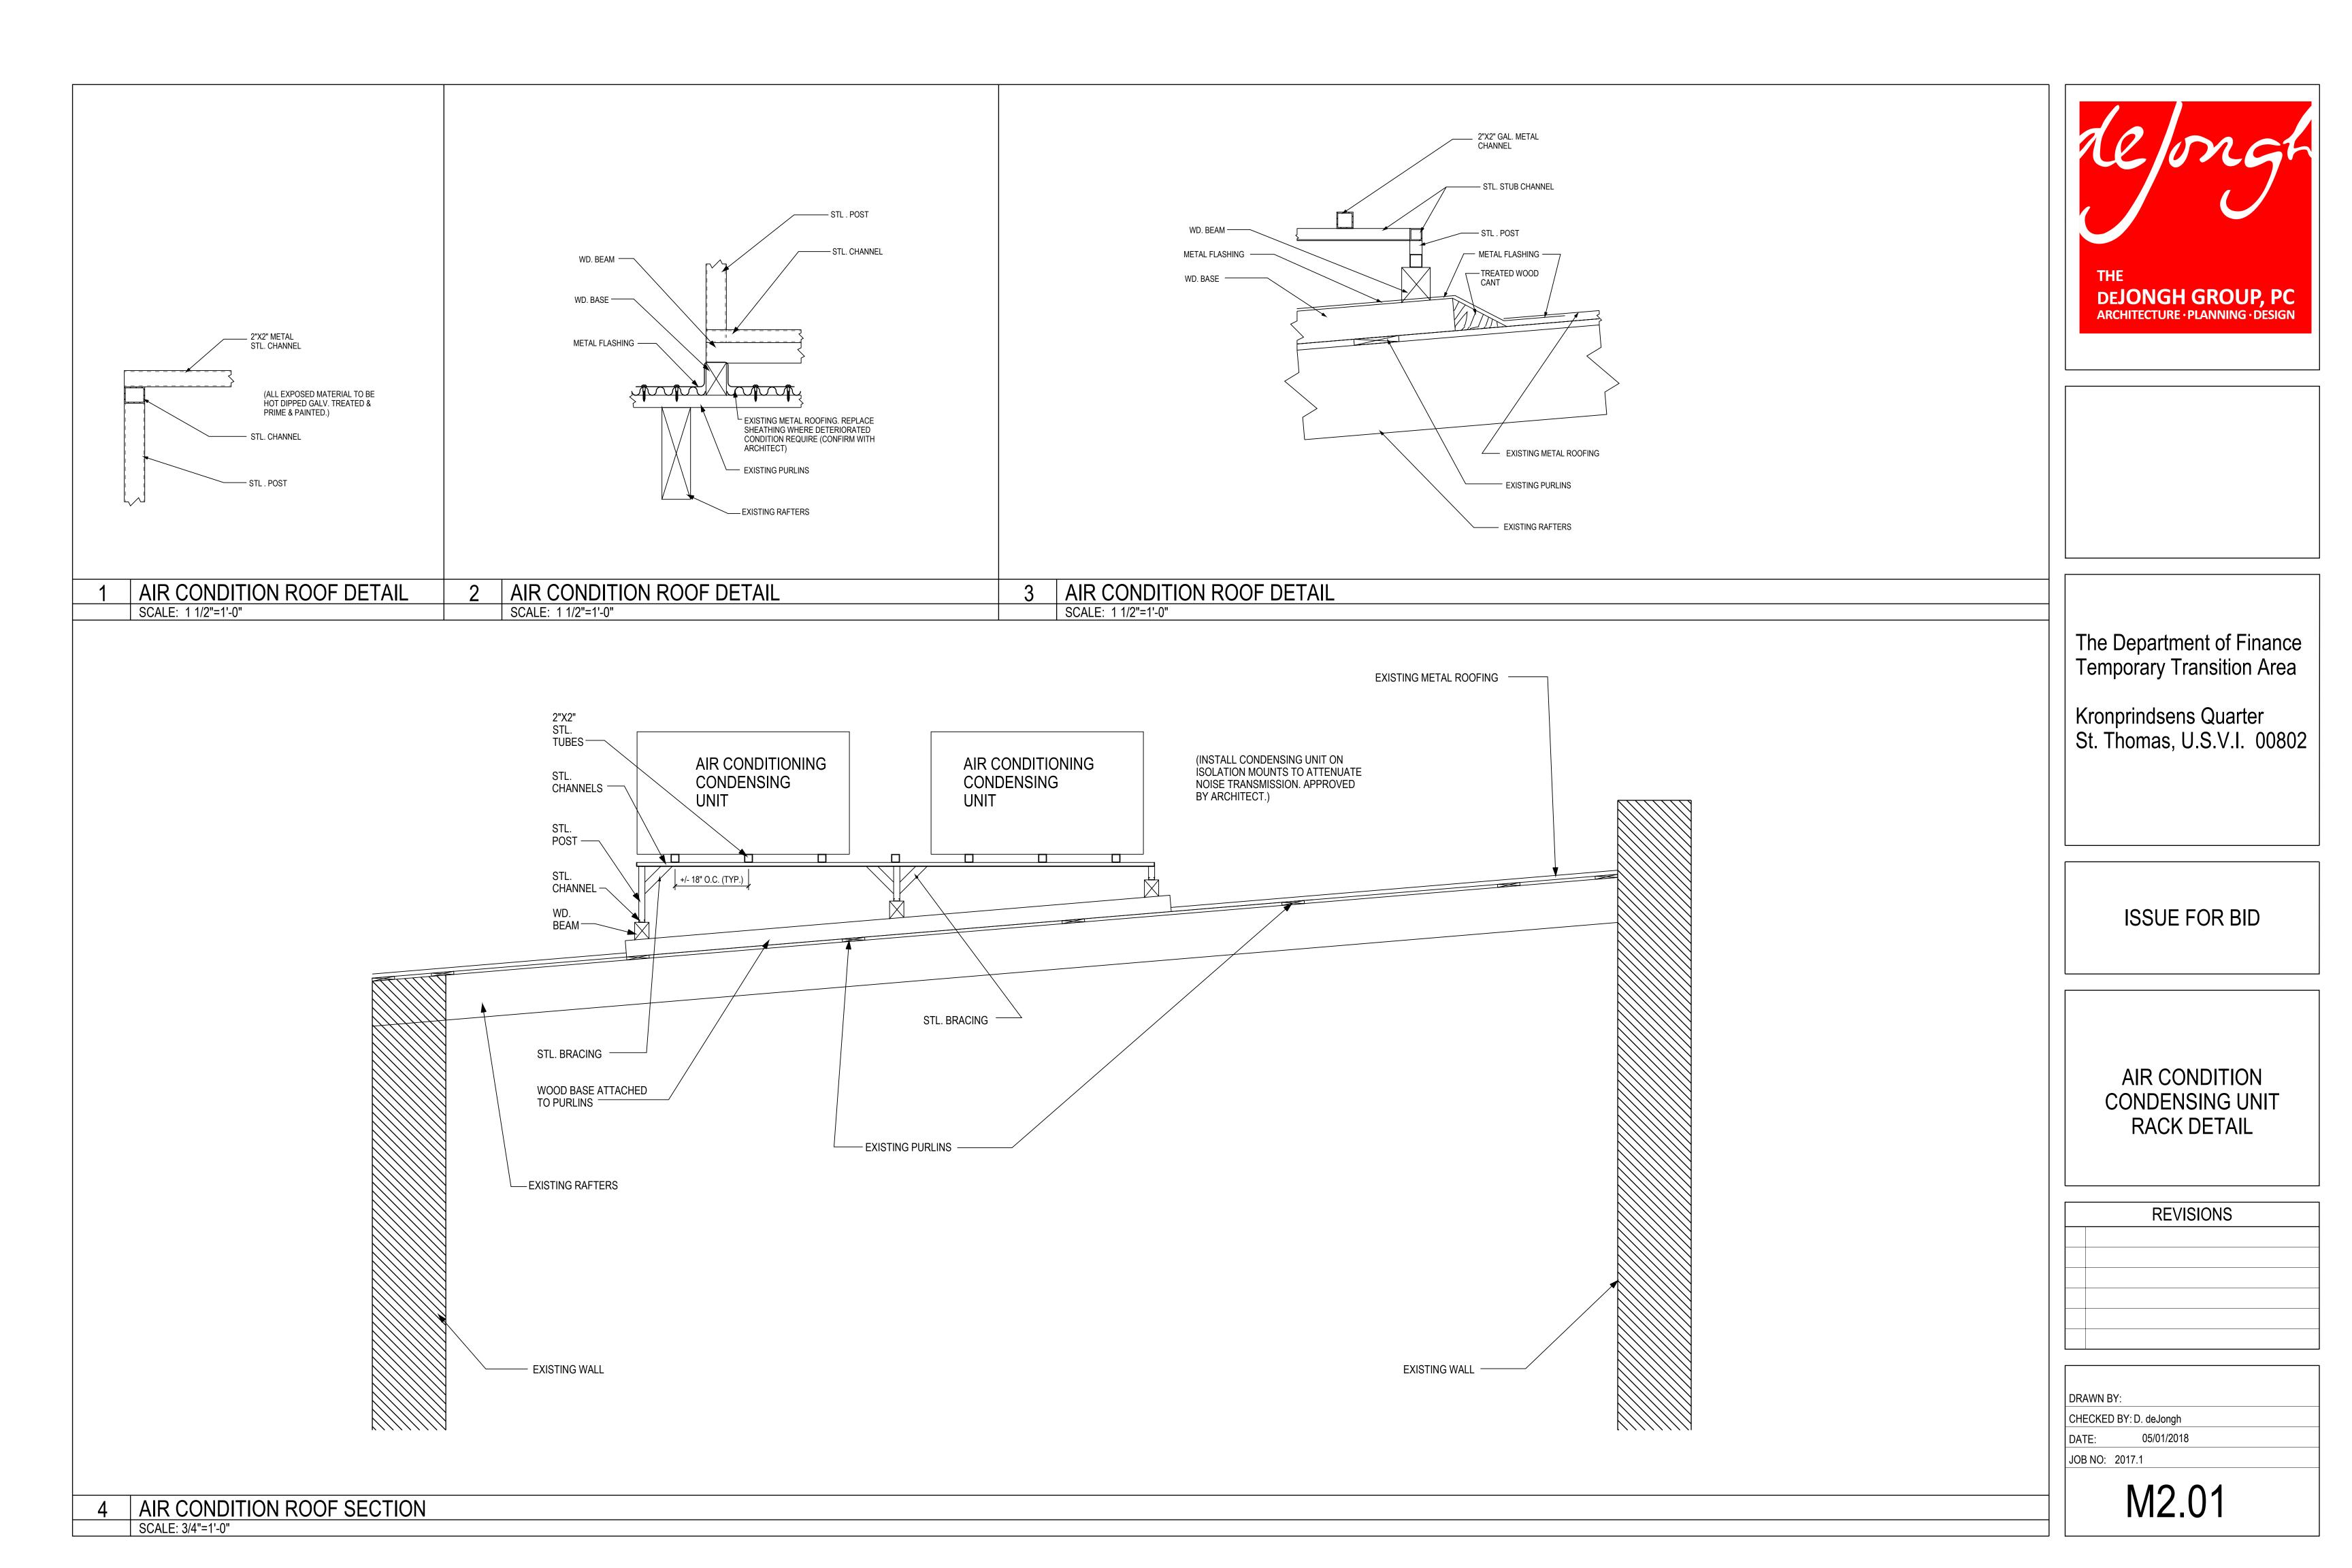

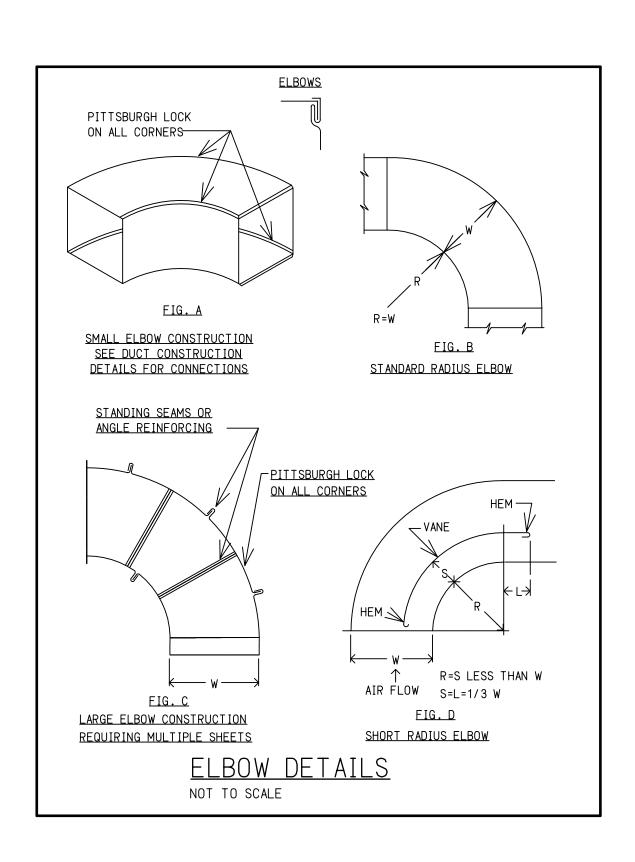

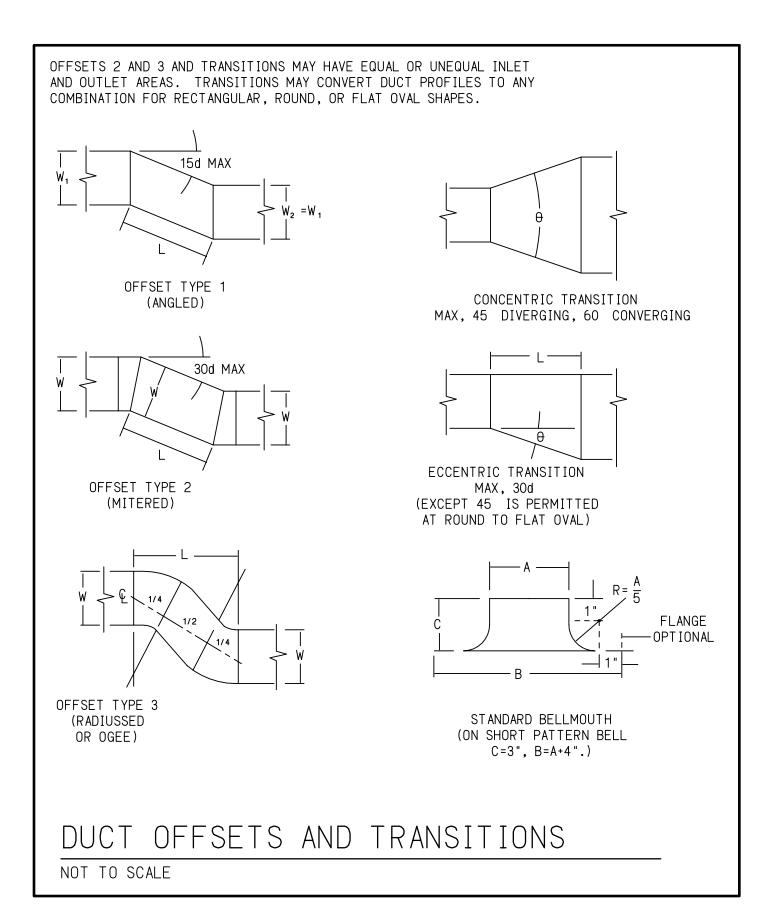

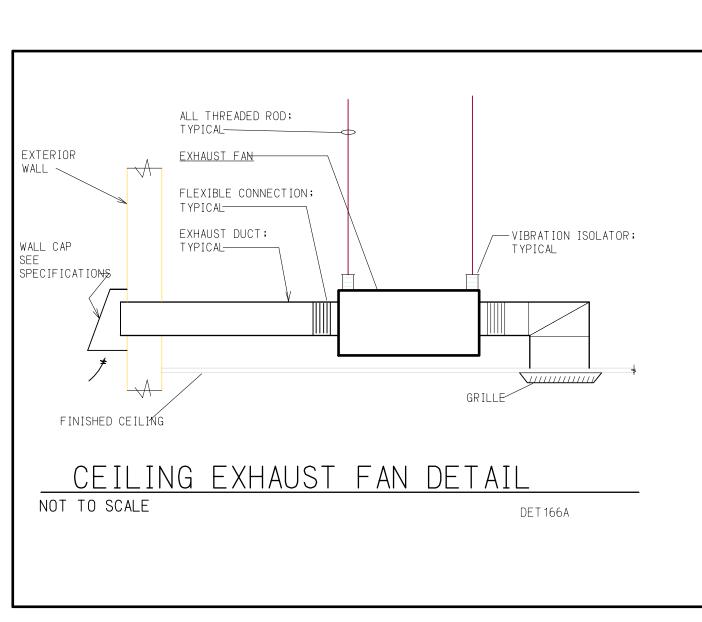

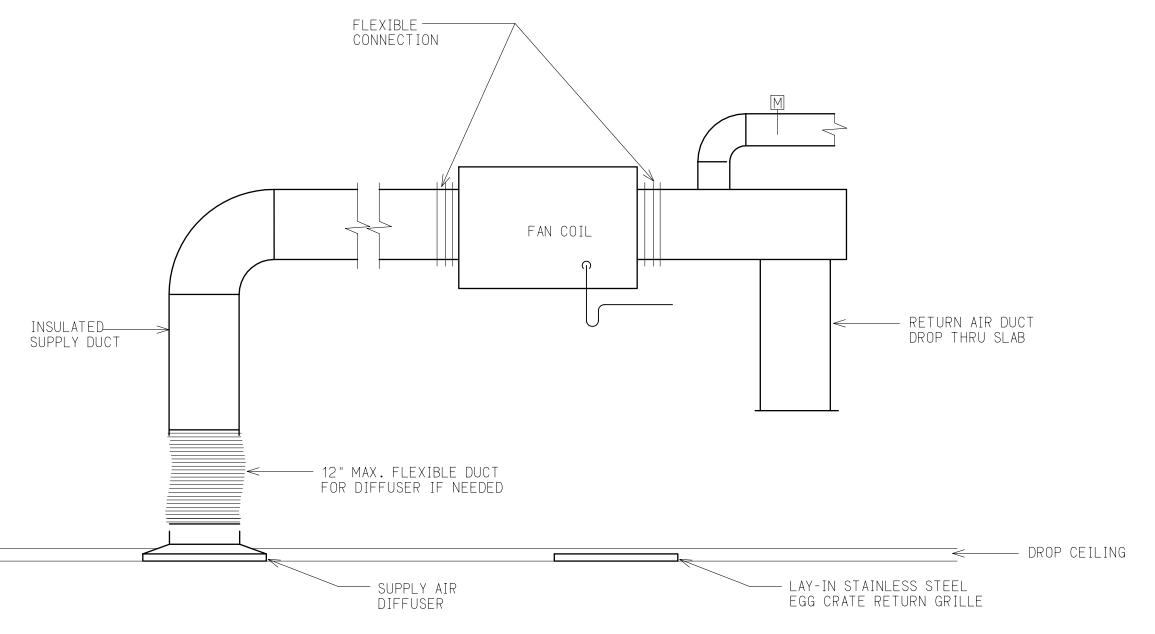

## GENERAL NOTES:

- A. Maximum N.C. values are based on Octave Band 1 through 8 sound power levels minus a room absorption of 10dB, re 10 to the -12 Watts.
- B. Verify border requirements with all applicable architectural sheets, reflected ceiling plans, and room finish schedules.
- C. All grilles, registers, and diffusers shall have visible sheet metal and ductwork painted flat black behind face.
- D. Only Perforated Diffusers with Individually Dampered Deflectors Mounted in Neck will be acceptable. All parts of Diffuser behind Perforated Face will be Painted Flat Black by Manufacturer.
- E. Provide square to round transitions, by Manufacturer, as required. Also see Plans.

# NOTES:

- 1. Provide baked enamel finish, Color as selected by Architect.
- 2. Provide Anodized Color as selected by Architect and Debris Screen and Re-inforcing.
- 3. Extra heavy duty grille, color as selected by Architect.
- 4. Fan coil layout shall be determined under MEP allowance.

# ATTIC MOUNTED FAN COIL

ITS



The Department of Finance Temporary Transition Area

Kronprindsens Quarter St. Thomas, U.S.V.I. 00802

ISSUE FOR BID

AIR CONDITION DETAILS AND NOTES

F	REV	ISI	0	NS

DRAWN BY:

CHECKED BY: D. deJongh


DATE: 05/01/2018

JOB NO: 2017.1

 $N12 \Omega2$ 

AIR CONDITION DETAILS AND NOTES

NOT TO SCALE

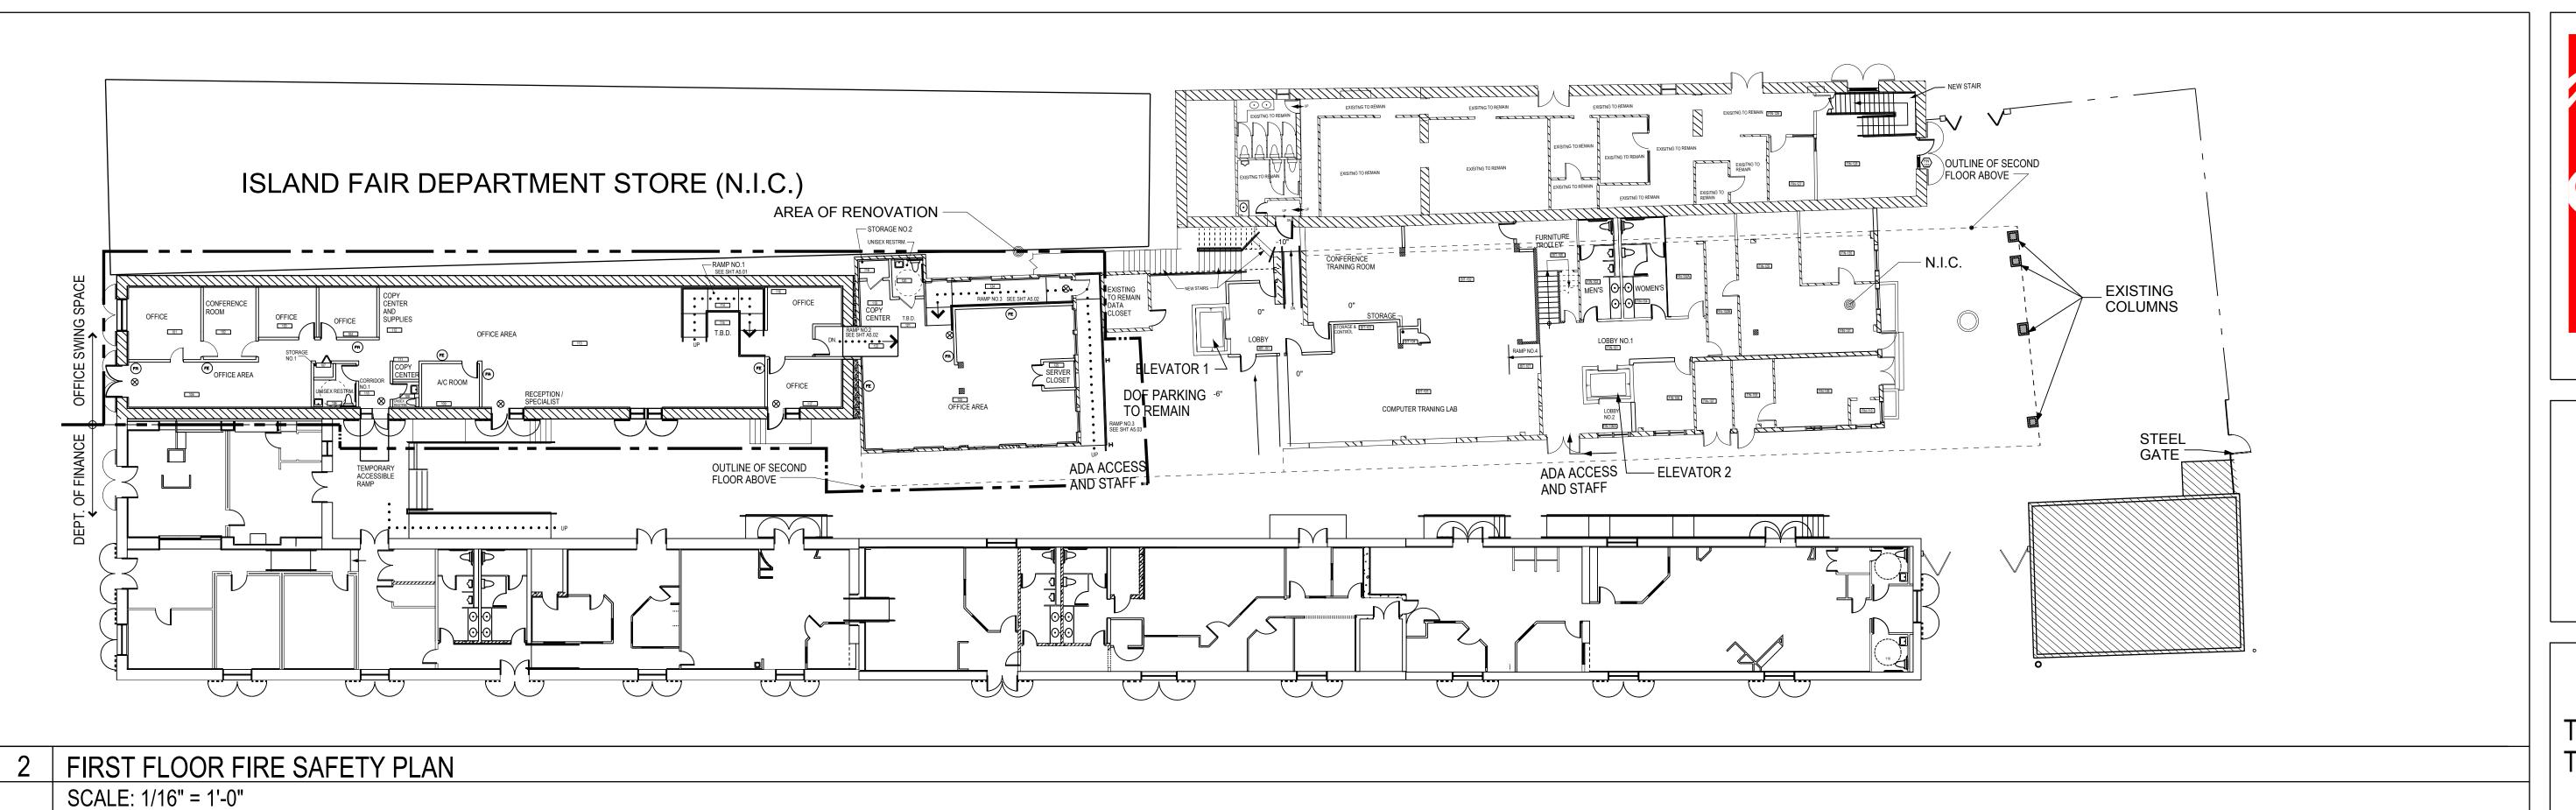



Kronprindsens Quarter St. Thomas, U.S.V.I. 00802

ISSUE FOR BID

FIRST FLOOR FIRE SAFETY PLAN

**REVISIONS** 


DRAWN BY: O.C. & B.S.

CHECKED BY: D. deJongh

DATE: 05/01/2018

JOB NO: 2017.1

FE1.01

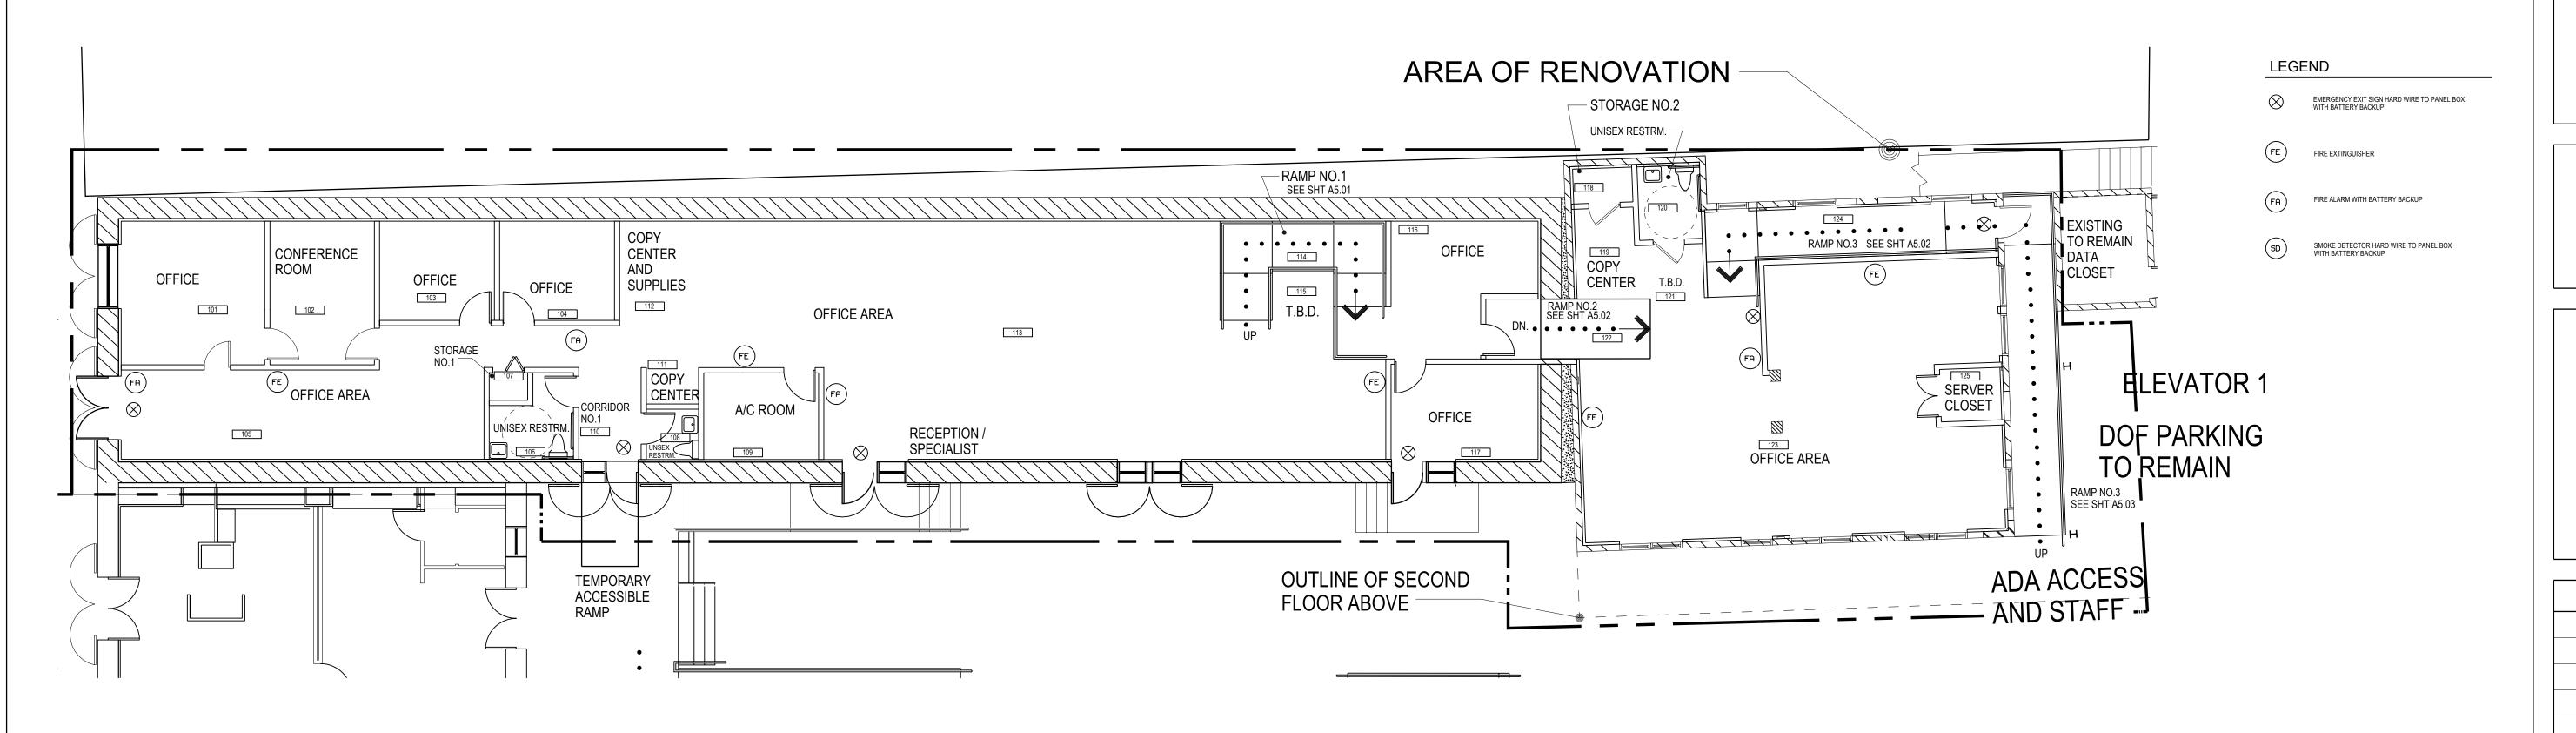

2 FIRST FLOOR FIRE SAFETY PLAN

SCALE: 1/8" = 1'-0"

(ENLARGEMENT)